MESASHELL BUILDING

1255 WEST RIO SALADO PARKWAY SUITE 207 TEMPE, AZ 85281 PHONE 480.268.2900 FAX 480.268.2905 W W W . A R I Z A D O . N E T



1257 SOUTH CRISMON ROAD MESA, ARIZONA 85208 4.2.2018

PROJECT MANAGER: MR. CHRIS COOPER A.I.A.

ROJECTTEAM

OWNER: ARCHITECT: **BRANDT BACUS** a.d. Arizado 1404 SOUTH LONGMORE ROAD 1255 WEST RIO SALADO PARKWAY SUITE 207 MESA, ARIZONA 85202

NATURAL GRADE NOT IN CONTRACT NIGHT LIGHT

OVERALL
OBSERVE
ON CENTER
OUTSIDE DIAMETER
OVERFLOW SCUPPER
OVERFLOW DRAIN

OCCUPATIONAL SAFETY AND HEALTH ADMINISTRATION

FIRE ALARM
FIRE ALARM CONTROL PANEL
FLOOR CLEANOUT
FEET
FINISH
FIXTURE
FLASHING
FLOOR
FIRE DAMPER, FLOOR DRAIN
FINISHED FLOOR
FLUORESCENT
FOOTING

F.D. F.F. FLUOR. FTG.

NOMINAL NOT TO SCALE

TEMPE, ARIZONA 85281 480.268.2900 FAX 480.268.2905 brandt@bacusfoodscorp.com E-MAIL cooper@arizado.net CONTACT MR. CHRIS COOPER A.I.A CONTRACTOR: FAX

CIVIL: DERICK SCHUMACHER 4450 NORTH 12TH STREET SUITE 228

PHOENIX, ARIZONA 85014 FAX dschumacher@cypresscivil.com E-MAIL MR. DERICK SCHUMACHER

STRUCTURAL: **CARUSO TURLEY SCOTT** 1215 WEST RIO SALADO PARKWAY

TEMPE, ARIZONA 85281 480.774.1700 480.774.1701 E-MAIL rdahlmann@ctsaz.com MR. RICHARD DAHLMANN LANDSCAPE: PINNACLE DESIGN, INC

1048 NORTH 44TH STREET

SUITE 200 PHOENIX, ARIZONA 85008 FAX 602.952.8686 E-MAIL

602.952.8585 EXT. 206 elorden@pdi-az.com MR. ED LORDEN

SHEET INDEX:

MECH./ELEC./PLUMB.

a.d. Arizado 1255 WEST RIO SALADO PARKWAY **SUITE 207** TEMPE, ARIZONA 85281 480.268.2900 480.268.2905 cooper@arizado.net E-MAIL CONTACT MR. CHRIS COOPER

PROJECT INFORMATION: **VICINITY MAP:**

E-MAIL

CONTACT MR. BRANDT BACUS **ABBREVIATIONS:** d PENNY
PERP. PERPENDICULAR
Ø PHASE
P.C. PRECAST
PG. PAGE
P.I.V. POST INDICATOR VALVE
P.L. PROPERTY LINE
PL PLATE
PLBG. PLUMBING
PLYWO.D
PNL. PAWCOD
PNL. PANEL
PR. PAIR
P.S.I. POUNDS PER SQ. INCH
P.S.F. POUNDS PER SQ. FOOT
PTD. PAINTED
PTN. PARTITION
PT. POINT
P.V.C. POLY VINYL CHLORIDE FOUNDATION FRAME FIBERGLASS REINF. PANEL FIRE HOSE CAB. AMERICANS with DISABILITIES ACT AMERICAN NATIONAL STANDARDS INSTITUTE ADDENDUM ANCHOR BOLT GAUGE
GALVANIZED
GENERAL CONTRACTOR
GRADE
GALVANIZED IRON AGGREGATE BASE COURSE AIR CONDITIONING ADDITION ABOVE FINISHED CEILING ABOVE FINISHED FLOOR ABOVE FINISHED GRADE AGGREGATE ALTERNATE ALUMINUM GLASS GRILLE GYPSUM AMPERE, AMPS ARCHITECT ASPHALT AVERAGE H.B. HOSE BIBB H.D.A.S. HEADED ANCHOR STUDS HARDENER HARDWARE H.M. HOLLOW METAL
HORIZ. HORIZONTAL
H.P. HIGH POINT
H.R. HAND RAIL
HTR. HEATER
HT. HEIGHT
H.V.A.C. HEATING, VETILATING, AND BOARD BUILDING BLOCKING BEAM BENCHMARK BOTTOM OF RADIUS
RETURN AIR
REFLECTED CEILING PLAN
ROUND
ROOF DRAIN
REGISTER
REINFORCED, REINFORCING AIR CONDITIONING HOT WATER REQ'D. REV. RFG. RGH. REUNFORCED, REIN REQUIRED REVISION ROOFING ROUGH ROOM ROOF TOP UNIT CABINET
CATCH BASIN
CEMENT
CERAMIC
CUBIC FEET
CUBIC FEET PER MINUTE
CAST IN PLACE
CORNERGUARD
CHANNEI INCH INSULATION INTERIOR INVERT SITE CONTRACTOR
STUCCO CONTROL JOINT
SCREW
SECTION
SELECT
SQUARE FEET
SHEET
SIDING
SIMILAR
SLIDING
SMOOTH
SHUT OFF VALVE
SPECIFICATION
SPLASH
SQUARE
STAINLESS STEEL
SOUND TRANSMISSION CLASS
STANDARD
STEEL
STRUCTURE
SUSPENDED
SWITCHBOARD
SYMETRICAL CHANNEL
CONTROL JOINT
CONSTRUCTION JOINT
CENTER LINE
CEILING
CLEAR
CENTIMETER JANITOR JUNCTION BOX JOINT JOIST CONCRETE MASONRY UNIT CLEAN OUT COLUMN CONCRETE CONNECTION CONSTRUCTION CONTINUOUS KIPS (1000 lbs) KICK PLATE KILOVOLT KILOVOLT-AMPS COL.
CONC.
CONN.
CONST.
CONT.
CONTR.
COR'G.
C.T. KILOWATT-HOUR CONTRACTOR CORRUGATED
CERAMIC TILE
COUNTER
COUNTERSUNK LAWATORY
POUNDS
LANDING
LINEAR FEET
LENGTH
LIVE LOAD
LONG LEG HORIZONTAL
LONG LEG VERTICAL
LOCATION SYMBOL LEGEND: CHECK VALVE
COLD WATER
COLD WATER PIPE SYMETRICAL TOP OF CURB TEMPERED GLASS DIAMETER DIAMETER
DECIBEL
DOUBLE
DIRECT CURRET
DEGREE
DETAIL
DIAGONAL
DIMENSION
DISPENSER
DEADLOAD
DOWN
DAMP PROOFING
DOWNSPOUT
DRAWING
DOWEL LONGITUDINAL
LIGHT
LATH
LOUVER
LIGHT CONCRETE DOOR TYPE ROOM NAME (TOP) AND ROOM THROUGH
TOP OF
TOP OF STEEL DECK
THERMOSTAT
TYPICAL NUMBER (BOTTOM) INTERIOR / EXTERIOR ELEVATION -ELEVATION No. (TOP), SHEET No. (BOTTOM) FINISH (BOTTOM) MATERIAL MAXIMUM MASONRY CONTROL JOINT UNDERWRITERS LABRATORIES UNLESS NOTED OTHERWISE
UNINTERRUPTIBLE POWER
SUPPLY $\begin{pmatrix} XX \\ XX \end{pmatrix}$ DETAIL REFERENCE - DETAIL No. (TOP), INTERIOR FINISHES & DECOR MECHANICAL METAL SHEET No. (BOTTOM) MANUFACTURER MAN HOLE, METAL HALIDE VENT
VOLT-AMPERE
VERTICAL
VERTICAL GRAIN
VESTIBULE
VINYL COMP. TILE
VITREOUS CLAY PIPE
VENT THROUGH ROOF BUILDING SECTION - SECTION No. (TOP), $\langle x \rangle$ FLOOR FINISHES METAL LATH MOULDING MASONRY OPENING MOISTURE RESISTANT SHEET No. (BOTTOM) ELECTRIC DRINKING EXHAUST FAN EXTERIOR INSULATING MAIN SWITCHBOARD MOUNTED MULLION EXTERIOR INSULATIN
FINISHING SYSTEM
EXPANSION JOINT
ELECTRIC
ELEVATION
EMPLOYEE
ENGINEER
EQUAL
EQUIPMENT
EXHAUST
EXHAUST
EXPANSION
EXTERIOR WALL SECTION - SECTION No. (TOP), X CEILING FINISHES SHEET No. (BOTTOM) EL.
ELEV.
EMP.
ENG.
EQ.
EQUIP.
EXH.
EXIST.
EXP.
EXT. WATER BASE
WATER CLOSET
WALL CLEANOUT
WOOD
WINDOW
WIDE FLANGE
WATER HEATER

WITH WITHOUT

W.O. W.P. W.W. W.W.F.

TRANSFORMER

WEATHER PROOF WINDOW WALL WELDED WIRE FABRIC WELDED WIRE MESH WIND LOAD

(x.x)

 $\langle xx \rangle$

BUILDING COLUMN GRID LINE


KEYED NOTE - SEE KEYED NOTES

COORDINATION SCHEDULE

WALL TYPE & DECOR

EQUIPMENT REFERENCE - SEE EQUIPMENT

WINDOW TYPE

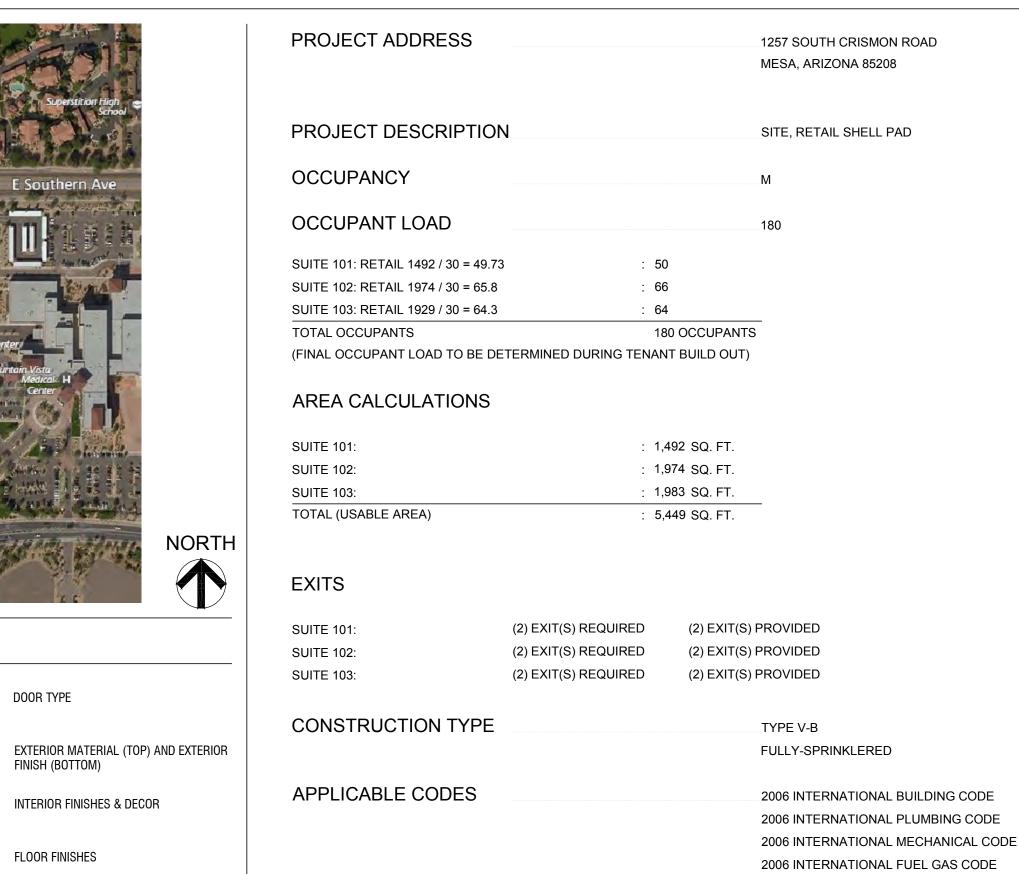

480.644.4273

PROJECT DIRECTORY:

DEVELOPMENT SERVICES

55 NORTH CENTER STREET

MESA, ARIZONA 85201

2005 NATIONAL ELECTRICAL CODE

2009 INTERNATIONAL ENERGY

CONSERVATION CODE

GENERAL TITLE SHEET CIVIL COVER SHEET GRADING AND DRAINAGE PLAN ONSITE UTILITY PLAN LANDSCAPE PL-1 COVER SHEET **ARCHITECTURAL** SPECIFICATIONS SITE PLAN SITE PLAN DETAILS EXTERIOR ELEVATIONS

N & SOUTH CRISMON TH CRISMON ROAD ARIZONA 85208 BUIL


SHEET TITLE TITLE SHEET


JOB NO A17392 DATE AS NOTED SCALE DRAWN CHECKED SHEET NO

PRELIMINARY IMPROVEMENT PLAN for 1257 SOUTH CRISMON ROAD

1257 SOUTH CRISMON ROAD MESA, ARIZONA

A PORTION NORTHWEST QUARTER OF SECTION 35, TOWNSHIP 1 NORTH, RANGE 7 EAST OF THE GILA AND SALT RIVER MERIDIAN MARICOPA COUNTY, ARIZONA

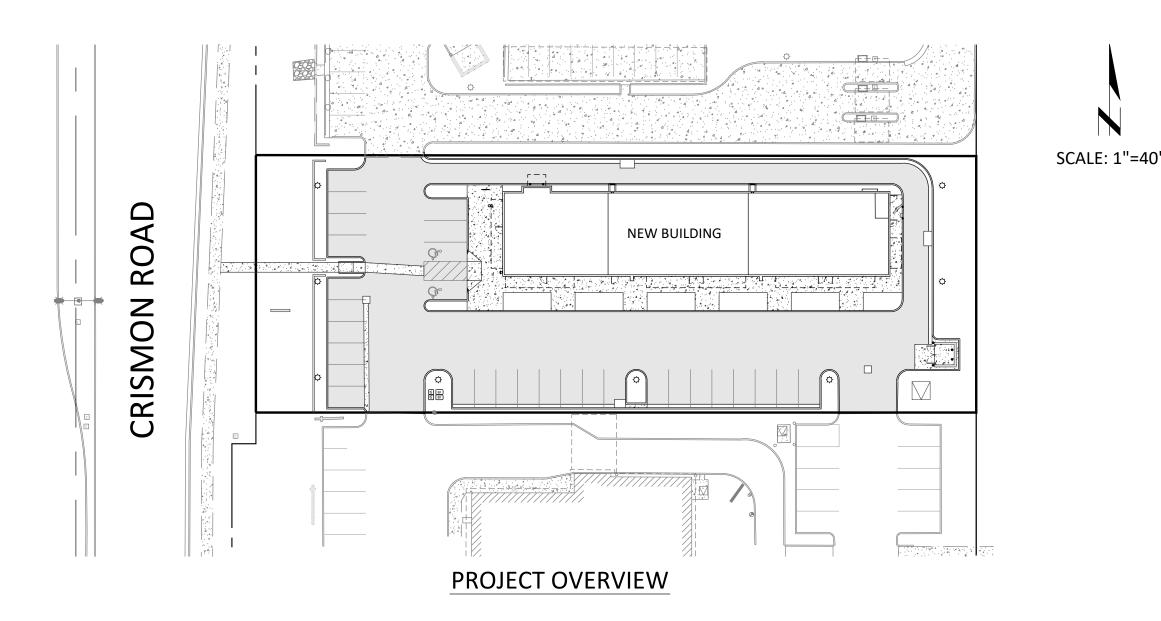

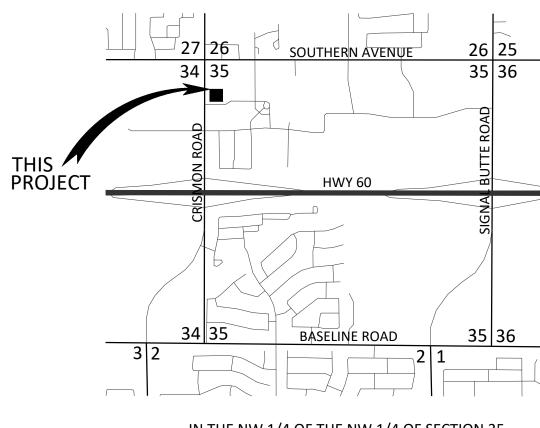


IN THE NW 1/4 OF THE NW 1/4 OF SECTION 35, T. 1 N., R. 7 E., G.&S.R.M., CITY OF MESA, MARICOPA COUNTY, ARIZONA

LOCATION MAP

NORTH

3" = 1 MILE

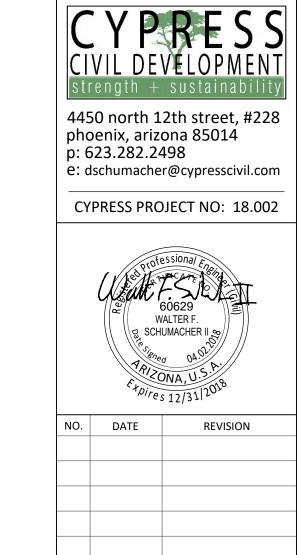

LAN for AD ZONA

RELIMINARY IMPROVEM 1257 SOUTH CRISMON ROAD M

OUTH LONGMORE ROAD ARIZONA 85202

BACUS FOOD CORP 1404 SOUTH LONGM

Δ

SITE ADDRESS
1257 SOUTH CRISMON ROAD
MESA, ARIZONA 85208
APN: 220-81-745B

SHEET NUMBER

21 1

PROJECT INFORMATION

- 1. PROJECT DESCRIPTION:
 THIS PROJECT CONSISTS OF THE CONSTRUCTION OF A FREE-STANDING
 SINGLE-STORY RETAIL BUILDING WITH DRIVE-THRU AREA AND REQUIRED
 PARKING, UTILITY, AND GRADING AND DRAINAGE REQUIREMENTS.
- ADDRESS:
 1257 SOUTH CRISMON ROAD MESA, ARIZONA 85208
- APN: 220-81-745B
- 3. ZONING: LC4. SITE AREA:
- NET AREA: 32,117 SF (0.74 AC)

SURVEY NOTES

- THE SURVEY FOR THIS PROJECT WAS PERFORMED BY: SUPERIOR SURVEYING SERVICES, INC. 2122 WEST LONE CACTUS DRIVE, SUITE 11 PHOENIX, ARIZONA 85027 PH: 623-869-0223
- CONTACT: DAVID S. KLEIN, R.L.S.
- 2. THE BASIS OF BEARINGS FOR THIS PROJECT IS THE MONUMENT LINE OF CRISMON ROAD, ALSO BEING THE WEST LINE OF THE NORTHWEST QUARTER OF SECTION 35, USING A BEARING OF N 00°00'22" E, PER THE FINAL PLAT OF CRISMON BUSINESS PARK AMENDED, RECORDED IN BOOK 775 OF MAPS, PAGE 39, RECORDS OF MARICOPA COUNTY, ARIZONA.
- 3. THE BASIS OF ELEVATION FOR THIS PROJECT IS THE BRASS TAG ON TOP OF CURB AT THE NORTHWEST CORNER OF BROADWAY ROAD AND CRISMON ROAD HAVING AN ELEVATION OF 1553.19 FEET, (NAVD 88), PER CITY OF MESA DATUM.

BENCHMARK

THE BENCHMARK USED FOR THIS THIS PROJECT IS THE BRASS TAG ON TOP OF CURB AT THE NORTHWEST CORNER OF BROADWAY ROAD AND CRISMON ROAD HAVING AN ELEVATION OF 1553.19 FEET, (NAVD 88), PER CITY OF MESA DATUM.

LEGAL DESCRIPTION

THAT PORTION OF LOT 3, AS SAID LOT IS SHOWN ON THE PLAT ENTITLED, "CRISMON BUSINESS PARK AMENDED" RECORDED SEPTEMBER 08, 2005 IN BOOK 775 OF MAPS, PAGE 39, RECORDS OF MARICOPA COUNTY, ARIZONA AND THEREAFTER CERTIFICATE OF CHANGE RECORDED IN RECORDING NO. 2007-1092936A, RECORDS OF MARICOPA COUNTY, ARIZONA, LOCATED IN A PORTION OF THE NORTHWEST QUARTER OF SECTION 35, TOWNSHIP 1 NORTH, RANGE 7 EAST, OF THE GILA AND SALT RIVER BASE AND MERIDIAN, MARICOPA COUNTY, ARIZONA, DESCRIBED AS FOLLOWS:

COMMENCING AT A FOUND BRASS CAP IN HAND HOLE MARKING THE NORTHWEST CORNER OF SAID SECTION 35, FROM WHICH A FOUND ADOT ALUMINUM CAP MARKING THE WEST QUARTER CORNER OF SAID SECTION 35 S 00°00'22" W, A DISTANCE OF 2636.41 FEET;

THENCE S 00°00'22" W ALONG THE WEST LINE OF SAID NORTHWEST QUARTER, A DISTANCE OF 509.75 FEET; THENCE S 89°55'57" E, A DISTANCE OF 75.00 FEET TO A POINT ON THE WEST LINE OF

SAID LOT 3 AND THE TRUE POINT OF BEGINNING;
THENCE CONTINUING S 89°55'57" E, A DISTANCE OF 300.00 FEET TO A POINT ON
THE WEST LINE OF SAID LOT 3;
THENCE S 00°00'22" W. ALONG THE FAST LINE A DISTANCE OF 106.89 FEET:

THENCE S 00°00'22" W, ALONG THE EAST LINE, A DISTANCE OF 106.89 FEET; THENCE N 90°00'00" W, A DISTANCE OF 300.00 FEET TO A POINT ON THE WEST LINE OF SAID LOT 3; THENCE N 00°00'22" E, ALONG THE WEST LINE, A DISTANCE OF 107.25 FEET TO THE

TRUE POINT OF BEGINNING.

FLOODPLAIN INFORMATION

ACCORDING TO THE FEDERAL EMERGENCY MANAGEMENT AGENCY FLOOD INSURANCE RATE MAP PANEL NUMBER 04013C2315L, DATED OCTOBER 15, 2013 THE PARCEL IS LOCATED IN THE ZONE X (SHADED) AREA, WHICH IS DEFINED AS AREAS OF 0.2% ANNUAL CHANCE FLOOD; AREAS OF 1% ANNUAL CHANCE FLOOD WITH AVERAGE DEPTHS OF LESS THAN 1 FOOT OR WITH DRAINAGE AREAS LESS THAN 1 SQUARE MILE; AND AREAS PROTECTED BY LEVEES FROM 1% ANNUAL CHANCE FLOOD.

DRAINAGE STATEMENT

SITE IS IN A SPECIAL FLOOD HAZARD AREA - NO
OFFSITE FLOWS AFFECT THIS SITE - NO
RETENTION PROVIDED IS 100-YEAR, 2-HOUR
EXTREME STORM OUTFALLS THE SITE AT THE DRIVEWAY LOCATED AT THE SOUTHWEST CORNER OF THE SITE SITE WITH AN ELEVATION OF 1509.45.

PROJECT RETENTION

REQUIRED VOLUME: 100-YEAR, 2-HOUR RETENTION: VOLUME [CF-FT] = C x (P [IN] / 12) x AREA [SF]

V = 0.85 x (2.18/12) x 32,117 = 4,959 CU.FT.

PROVIDED VOLUME:
TOTAL PROVIDED VOLUME = 5,026 CU.FT. VIA 100 LF OF 96" DIAMETER UNDERGROUND CMP STORM WATER RETENTION TANK.

DRYWELL CALCULATIONS

TOTAL VOLUME = 4,959 CF

DRYWELL DISSIPATION RATE = 0.1 CFS

TIME [SEC] = VOLUME [CF] / RATE [CFS]

t = 4,959 / 0.1 = 49,570 SEC = 13.8 HOURS

	PROJECT BOUNDARY LINE
	OTHER PARCEL LINE
	ROADWAY CENTERLINE
	FLOW-LINE
	EXISTING EASEMENT
—2321—	EXISTING CONTOUR
	EXISTING CONCRETE
	EXISTING RIP RAP
7277 / 7277 / 7277	EXISTING WALL
	NEW ASPHALT
4	NEW CONCRETE
777777777777	NEW WALL
	EXISTING CURB
	EXISTING PAINT STRIPE
	NEW CURB
	NEW PAINT STRIPE
	EXISTING STORM DRAIN PIPE
—— Е ——	EXISTING UNDERGROUND ELECTRIC
s	EXISTING SEWER MAIN
	EXISTING WATER MAIN
—— F ——	EXISTING FIRE SERVICE
G	EXISTING GAS LINE
	NEW STORM DRAIN PIPE
s	NEW SEWER MAIN
——— W ———	NEW WATER MAIN
—— F ——	NEW FIRE SERVICE

— - - - — RIGHT-OF-WAY

•	EXISTING FIRE HYDRANT
	EXISTING TRANSFORMER
JB	EXISTING JUNCTION BOX
Е	EXISTING ELECTRIC PULL BOX
•——	EXISTING STREET LIGHT
С	EXISTING COMMUNICATION PULLBO
L	EXISTING LIGHT PULL BOX
(CO)	NEW SEWER CLEANOUT
	NEW WATER VALVE
W	NEW WATER METER
BF	NEW BACKFLOW PREVENTER
(E)	NEW FIRE CONNECTION
	NEW DRYWELL
	NEW TRANSFORMER
	NEW SIGN
\Diamond	NEW SITE LIGHT
\bigcirc	SURVEY MONUMENT AS NOTED
• (99.99P)	SPOT ELEV. (EXIST. GRADE)
• 99.99P R.O.W.	SPOT ELEV. (NEW GRADE)
(R)	RIGHT-OF-WAY RECORDED VALUE
(M)	MEASURED VALUE
Р	PAVEMENT (ASPHALT)
С	CONCRETE
TC	TOP OF CURB
FG	FINISHED GRADE
GB	GRADE BREAK
FFE	FINISHED FLOOR ELEVATION

EXISTING SEWER MANHOLE

EXISTING SEWER CLEANOUT

EXISTING GREASE TRAP MANHOLE

LEGEND

UTILITIES

WATER: CITY OF MESA
SEWER: CITY OF MESA
ELECTRIC: SALT RIVER PROJECT
GAS: SOUTHWEST GAS
TELEPHONE: CENTURY LINK
CABLE: COX COMMUNICATIONS

DEVELOPER

BACUS FOOD CORP 1404 SOUTH LONGMORE ROAD MESA, ARIZONA 85202 PH: 480-696-4274 ATTN: BRANDT BACUS

CIVIL ENGINEER


CYPRESS CIVIL DEVELOPMENT 4450 NORTH 12TH STREET, #228 PHOENIX, ARIZONA 85014 PH: 623-282-2498 ATTN: DERICK SCHUMACHER

ARCHITECT

ARIZADO ARCHITECTURE DESIGN 1255 WEST RIO SALADO PARKWAY, #207 TEMPE, ARIZONA 85281 PH: 480-268-2900 ATTN: CHRIS COOPER


SHEET INDEX

COVER SHEET
 GRADING AND DRAINAGE PLAN
 ONSITE UTILITY PLAN

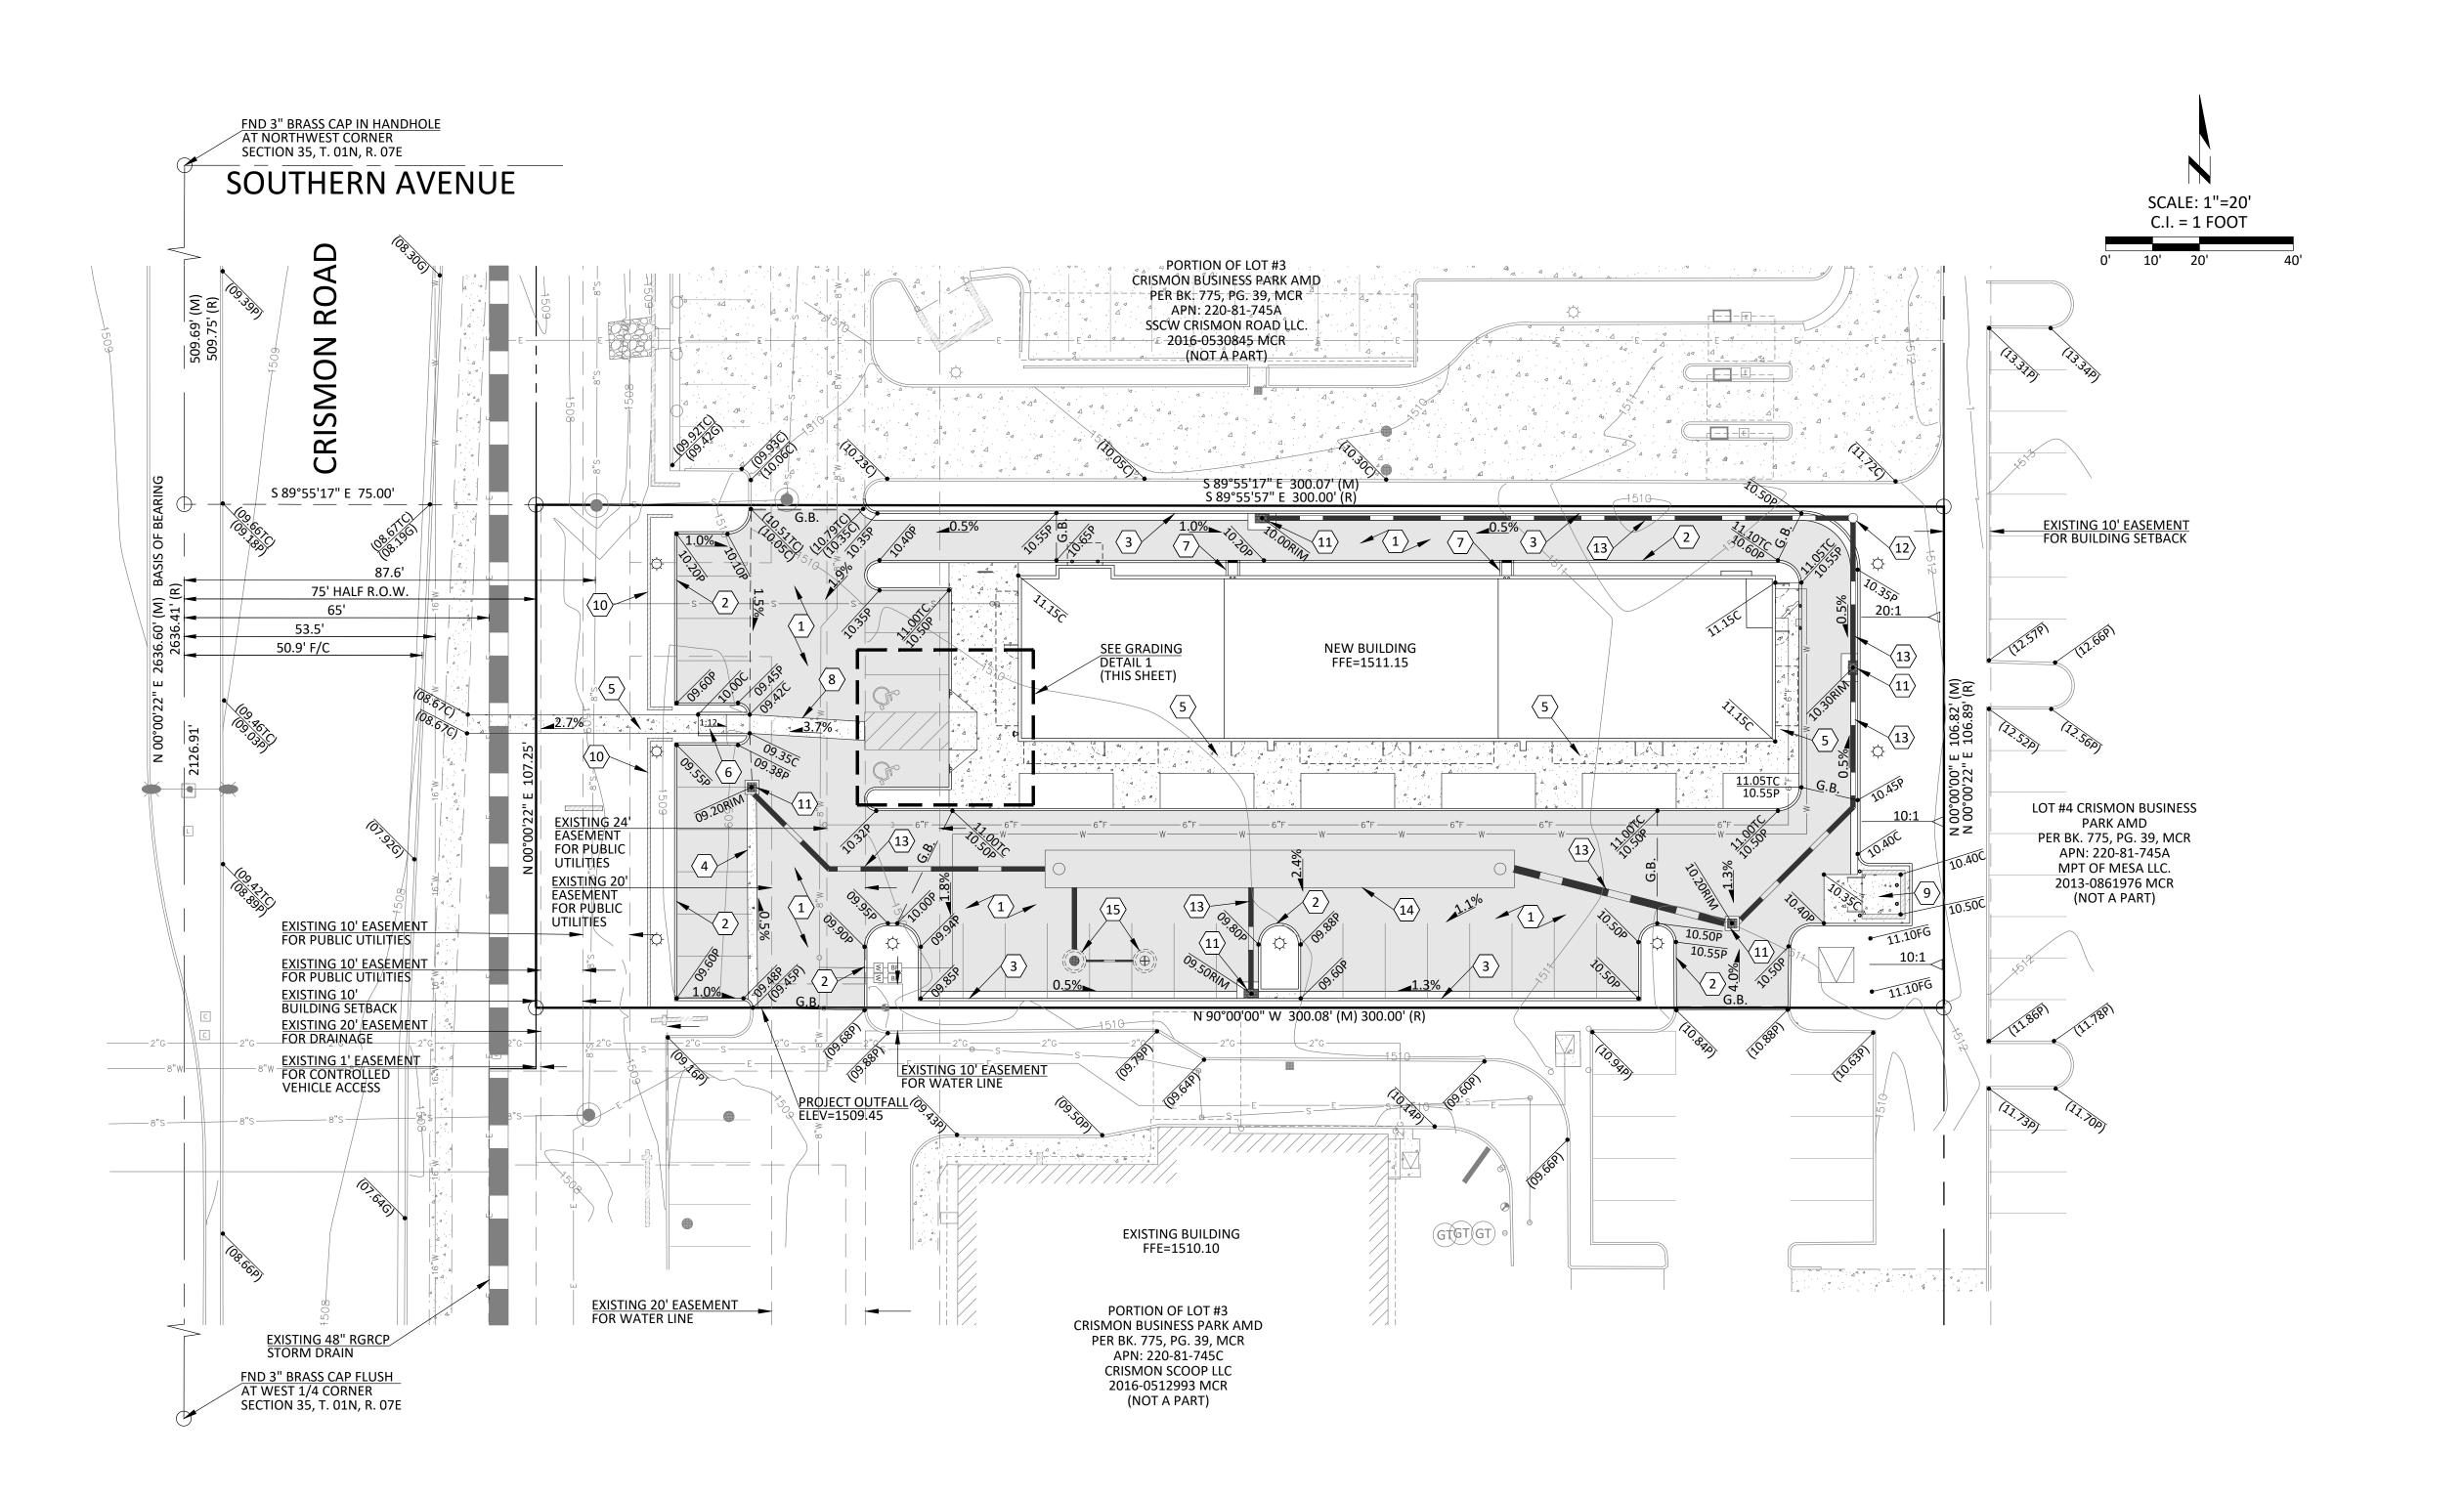

KEYNOTES

- \langle 1 angle NEW ASPHALT PAVEMENT.
- 2 NEW CONCRETE VERTICAL CURB.
- (3) NEW CONCRETE VERTICAL CURB AND GUTTER.
- 4 NEW VALLEY GUTTER.
- 5 NEW CONCRETE SIDEWALK.
- \langle 6 \rangle NEW ACCESSIBLE ACCESS RAMP.
- (7) NEW CURB OPENING AND CONCRETE GUTTER AT ROOF DRAIN.
- \langle 8 \rangle NEW DECORATIVE CONCRETE CROSSWALK.
- (9) NEW TRASH ENCLOSURE. REFER TO ARCHITECTURAL ✓ PLANS.
- 10 NEW MASONRY SCREEN WALL. REFER TO ARCHITECTURAL PLANS.
- $\langle 11 \rangle$ NEW STORM DRAIN INLET.
- $\langle 12
 angle$ NEW STORM DRAIN MANHOLE.
- $\langle 13 \rangle$ NEW STORM DRAIN PIPE.
- NEW 96" DIAMETER CMP UNDERGROUND STORMWATER RETENTION TANK.
 LENGTH=100 LINEAR FEET
 VOLUME=5,026 CUBIC FEET
- $\overline{\langle 15 \rangle}$ NEW DUAL-CHAMBER DRYWELL.

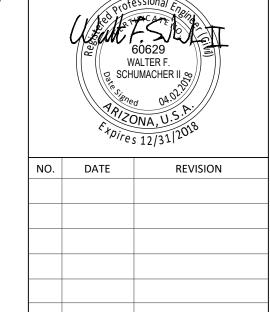

4450 north 12th street, #228 phoenix, arizona 85014 p: 623.282.2498

e: dschumacher@cypresscivil.com

CYPRESS PROJECT NO: 18.002

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grading

GRADING DETAIL 1


1"=10'

PRELIMINARY IM 1257 SOUTH CRISN

DEVELOPER
BACUS FOOD CORP
1404 SOUTH LONGMORE F
MESA, ARIZONA 85202

SHEET NUMBER

2 of 3

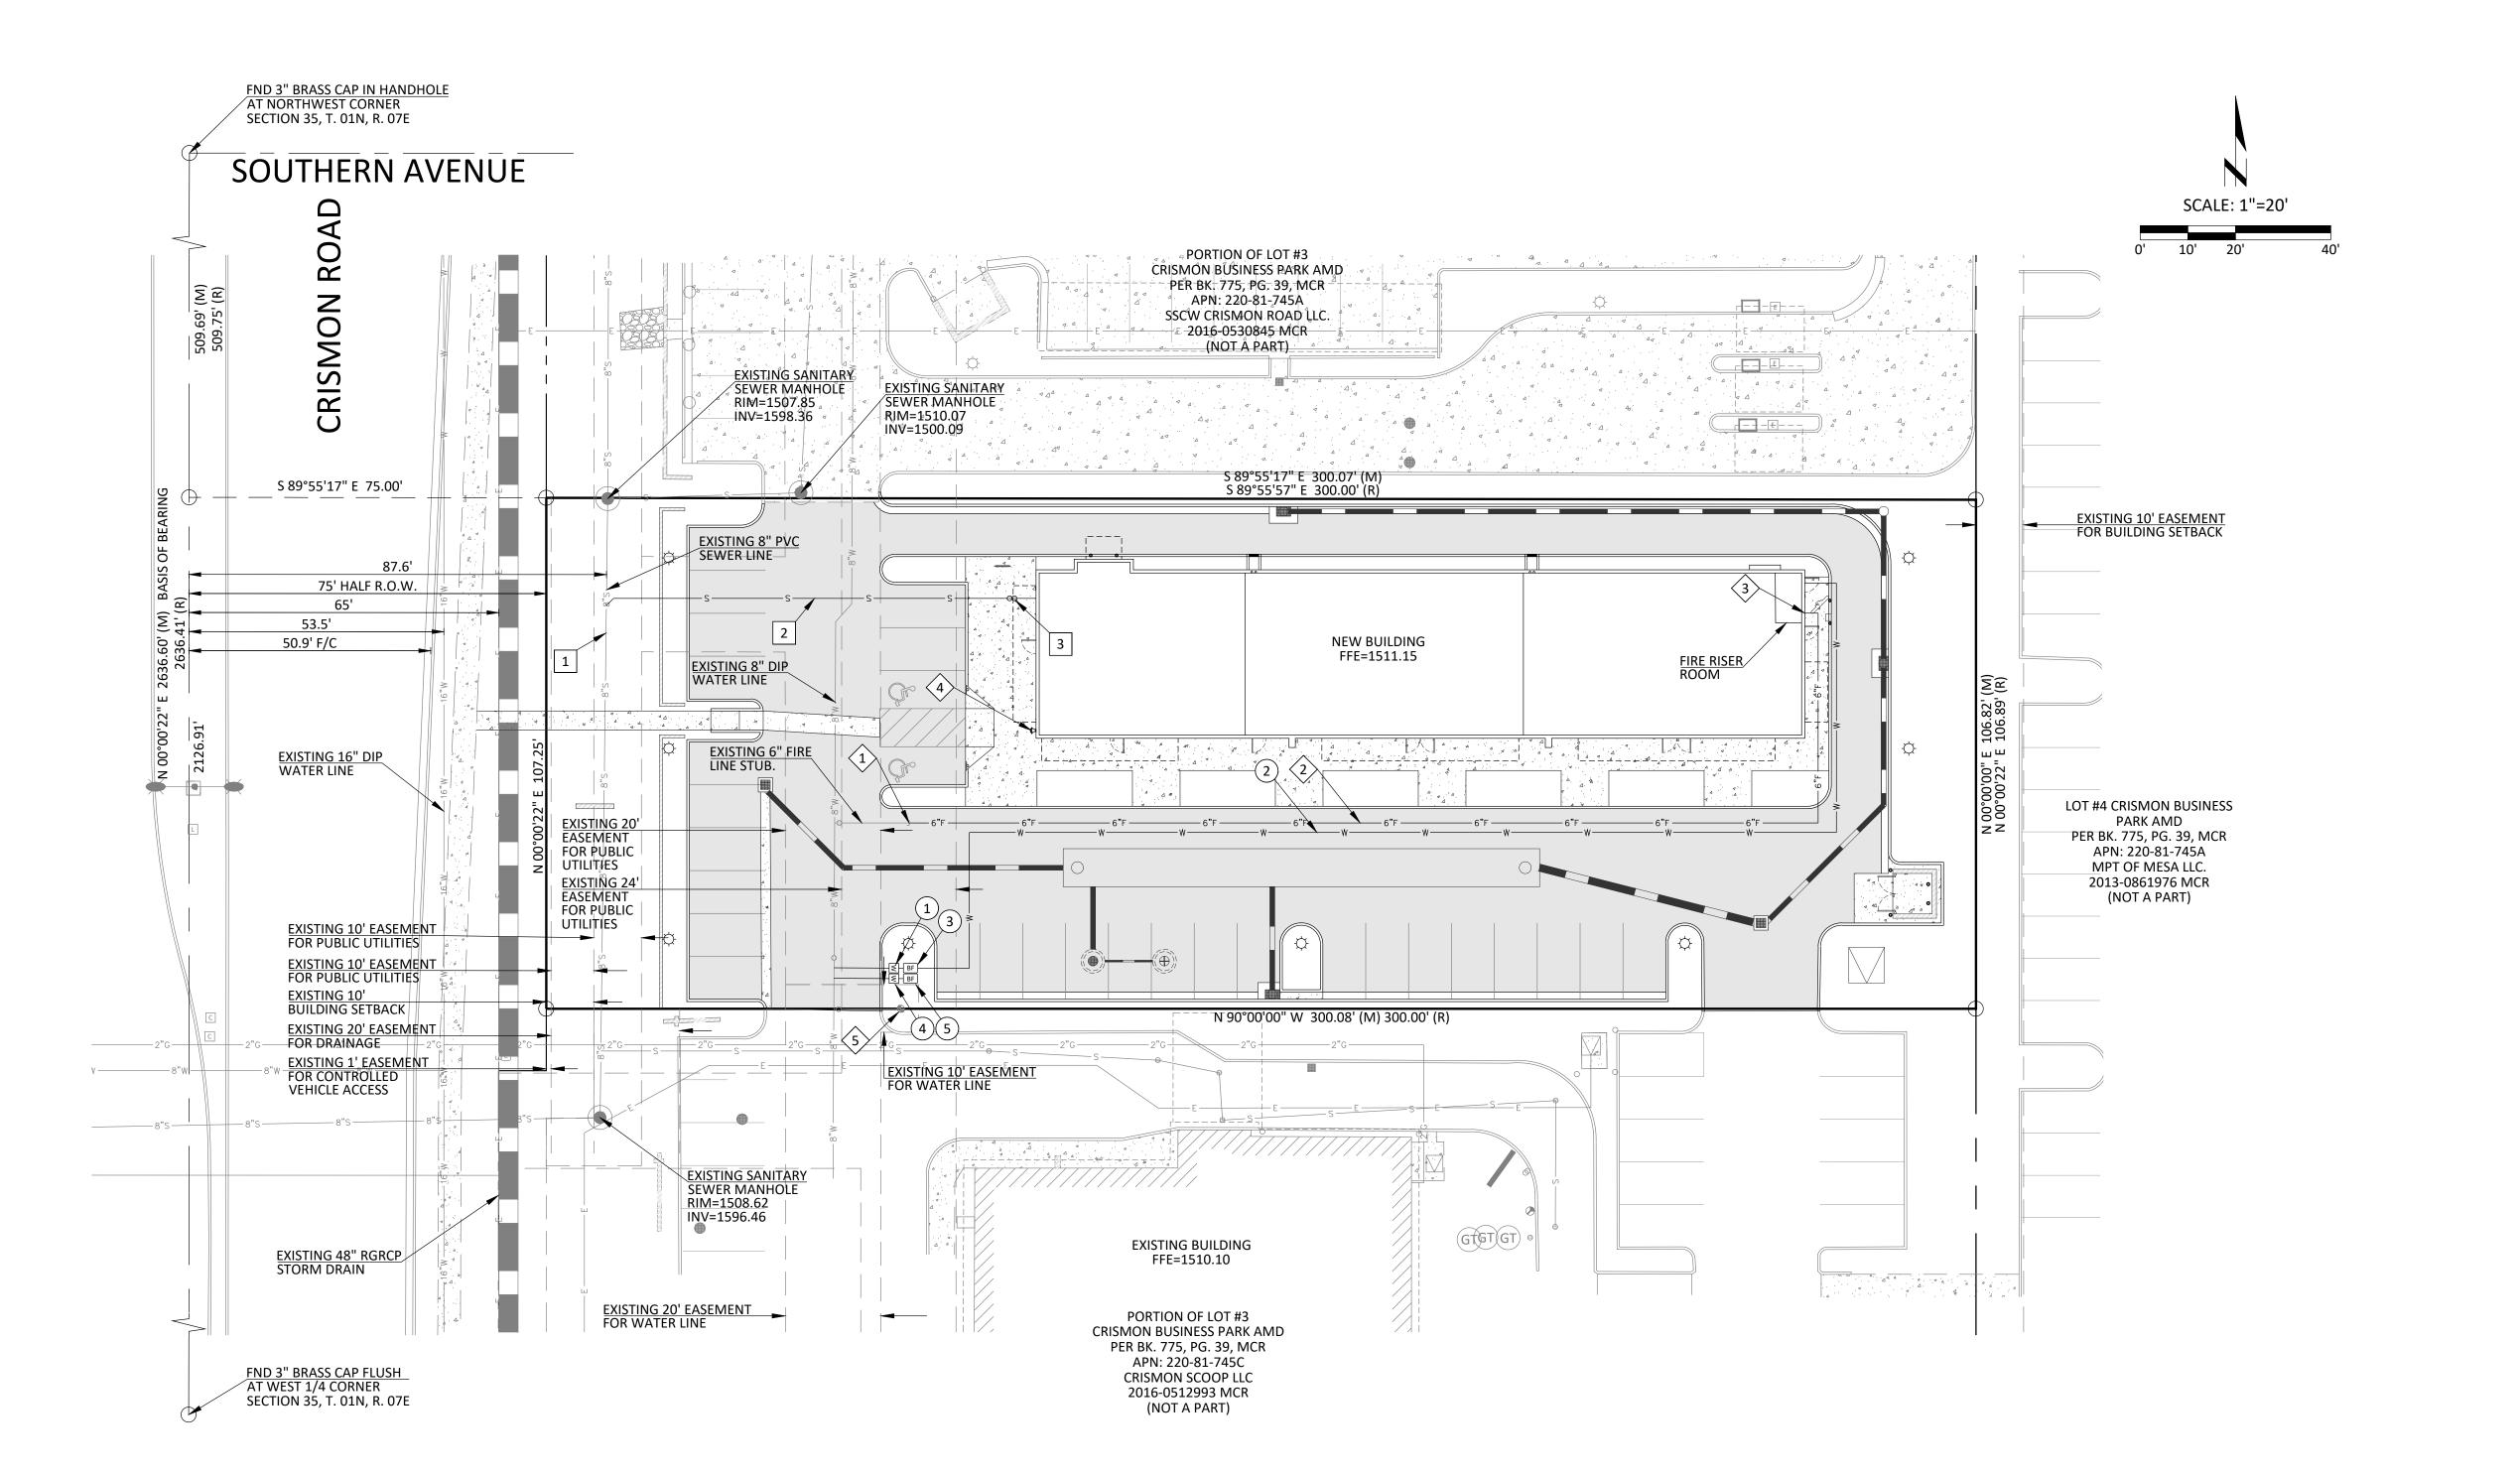

PRIVATE WATER KEYNOTES

- 1 NEW 2" SERVICE AND METER FOR DOMESTIC WATER SERVICE.
- 2 NEW 2" DOMESTIC WATER LINE.
- (3) NEW DOMESTIC BACKFLOW PREVENTER.
- (4) NEW 3/4" SERVICE AND METER FOR IRRIGATION SERVICE.
- 5 NEW IRRIGATION BACKFLOW PREVENTER.

PRIVATE FIRE LINE KEYNOTES

- 1 CONNECT TO EXISTING 6" FIRE STUB FOR FIRE SERVICE.
- 2 NEW 6" DIP FIRE LINE.
- NEW 6" BACKFLOW PREVENTER WITHIN FIRE RISER ROOM.
- NEW FDC LOCATION.
- 5 EXISTING FIRE HYDRANT TO REMAIN.

PRIVATE SEWER KEYNOTES

- 1 TAP EXISTING TO EXISTING 8" PVC SEWER MAIN.
- NEW 6" PVC SDR-35 SEWER LINE. 2% MINIMUM SLOPE.
- NEW TWO-WAY SEWER CLEAN OUT.

CYPRE	ςς
CIVIL DEVELOR	MENT
strength + sustai	nability

4450 north 12th street, #228 phoenix, arizona 85014 p: 623.282.2498 e: dschumacher@cypresscivil.com



Expires 12/31/2018						
NO.	DATE	REVISION				

N for ✓

ELIMINARY IMPROVEMENT PLAN 1257 SOUTH CRISMON ROAD 1257 SOUTH CRISMON ROAD MESA, ARIZON,

<u>d</u>

onsi

DEVELOPER
BACUS FOOD CORP
1404 SOUTH LONGMORE ROAD
MESA, ARIZONA 85202

PRE

SITE ADDRESS
1257 SOUTH CRISMON ROAD
MESA, ARIZONA 85208
APN: 220-81-745B

SHEET NUMBER

3 of 3



Call at least two full working day

al 8-1-1 or 1-800-STAKE-IT (782-5

LANDSC

PRELIMINARY SHE Drawn By: Job No: 18002 1.4.18

CONTACT INFORMATION

TEMPE, AZ 85281

CONTACT: BRET WEST

PHONE: 480.268.2900 EMAIL: bret@arizado.net

PINNACLE DESIGN, INC.


PHOENIX, AZ 85008

CONTACT: ED LORDEN PHONE: 602.952.8585

EMAIL: elorden@pdi-az.com

ARIZADO 1255 W RIO SALADO PARKWAY, STE. 207

1048 NORTH 44TH STREET, STE. 200

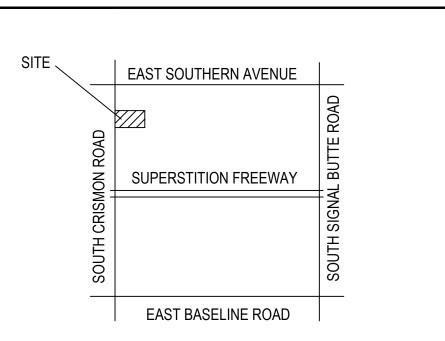

PROJECT CONSULTANTS

DISCIPLINE

ARCHITECT:

LANDSCAPE

ARCHITECT:

VICINITY MAP

PRELIMINARY LANDSCAPE NOTES

PLANTING

THE SITE WILL BE LANDSCAPED IN ACCORDANCE WITH THE CITY OF MESA STANDARDS. ALL TREES AND SHRUBS ARE TO BE STAKED AND PLANTED IN ACCORDANCE WITH THE ARIZONA NURSERY ASSOCIATION PUBLISHED STANDARDS.

SIZES OF TREES AND SHRUBS WILL CORRESPOND WITH REQUIREMENTS SET BY THE CITY OF MESA. ALL PLANTING AREAS WILL RECEIVE A 2" DEPTH OF DECOMPOSED GRANITE AND SHALL BE TREATED WITH PRE-EMERGENT HERBICIDE.

IRRIGATION


THE IRRIGATION SYSTEM WILL CONSIST OF DRIP EMITTERS AND PRESSURE REGULATORS CONNECTED TO AUTOMATIC VALVES AND WILL BE TIED INTO AUTOMATIC CONTROLLERS AS REQUIRED. THE IRRIGATION SYSTEM SHALL PROVIDE 100% COVERAGE.


GRADING

ALL EARTHWORK WILL BE DONE SO THAT ALL MOISTURE DRAINS OFF AND AWAY FROM SIDEWALKS AND STRUCTURES. THE MAJORITY OF ONSITE DRAINAGE WILL DRAIN INTO THE RETENTION BASINS LOCATED ON SITE.

1257 S. CRISMON ROAD MESA, AZ. 85208

PRELIMINARY-NOT FOR CONSTRUCTION

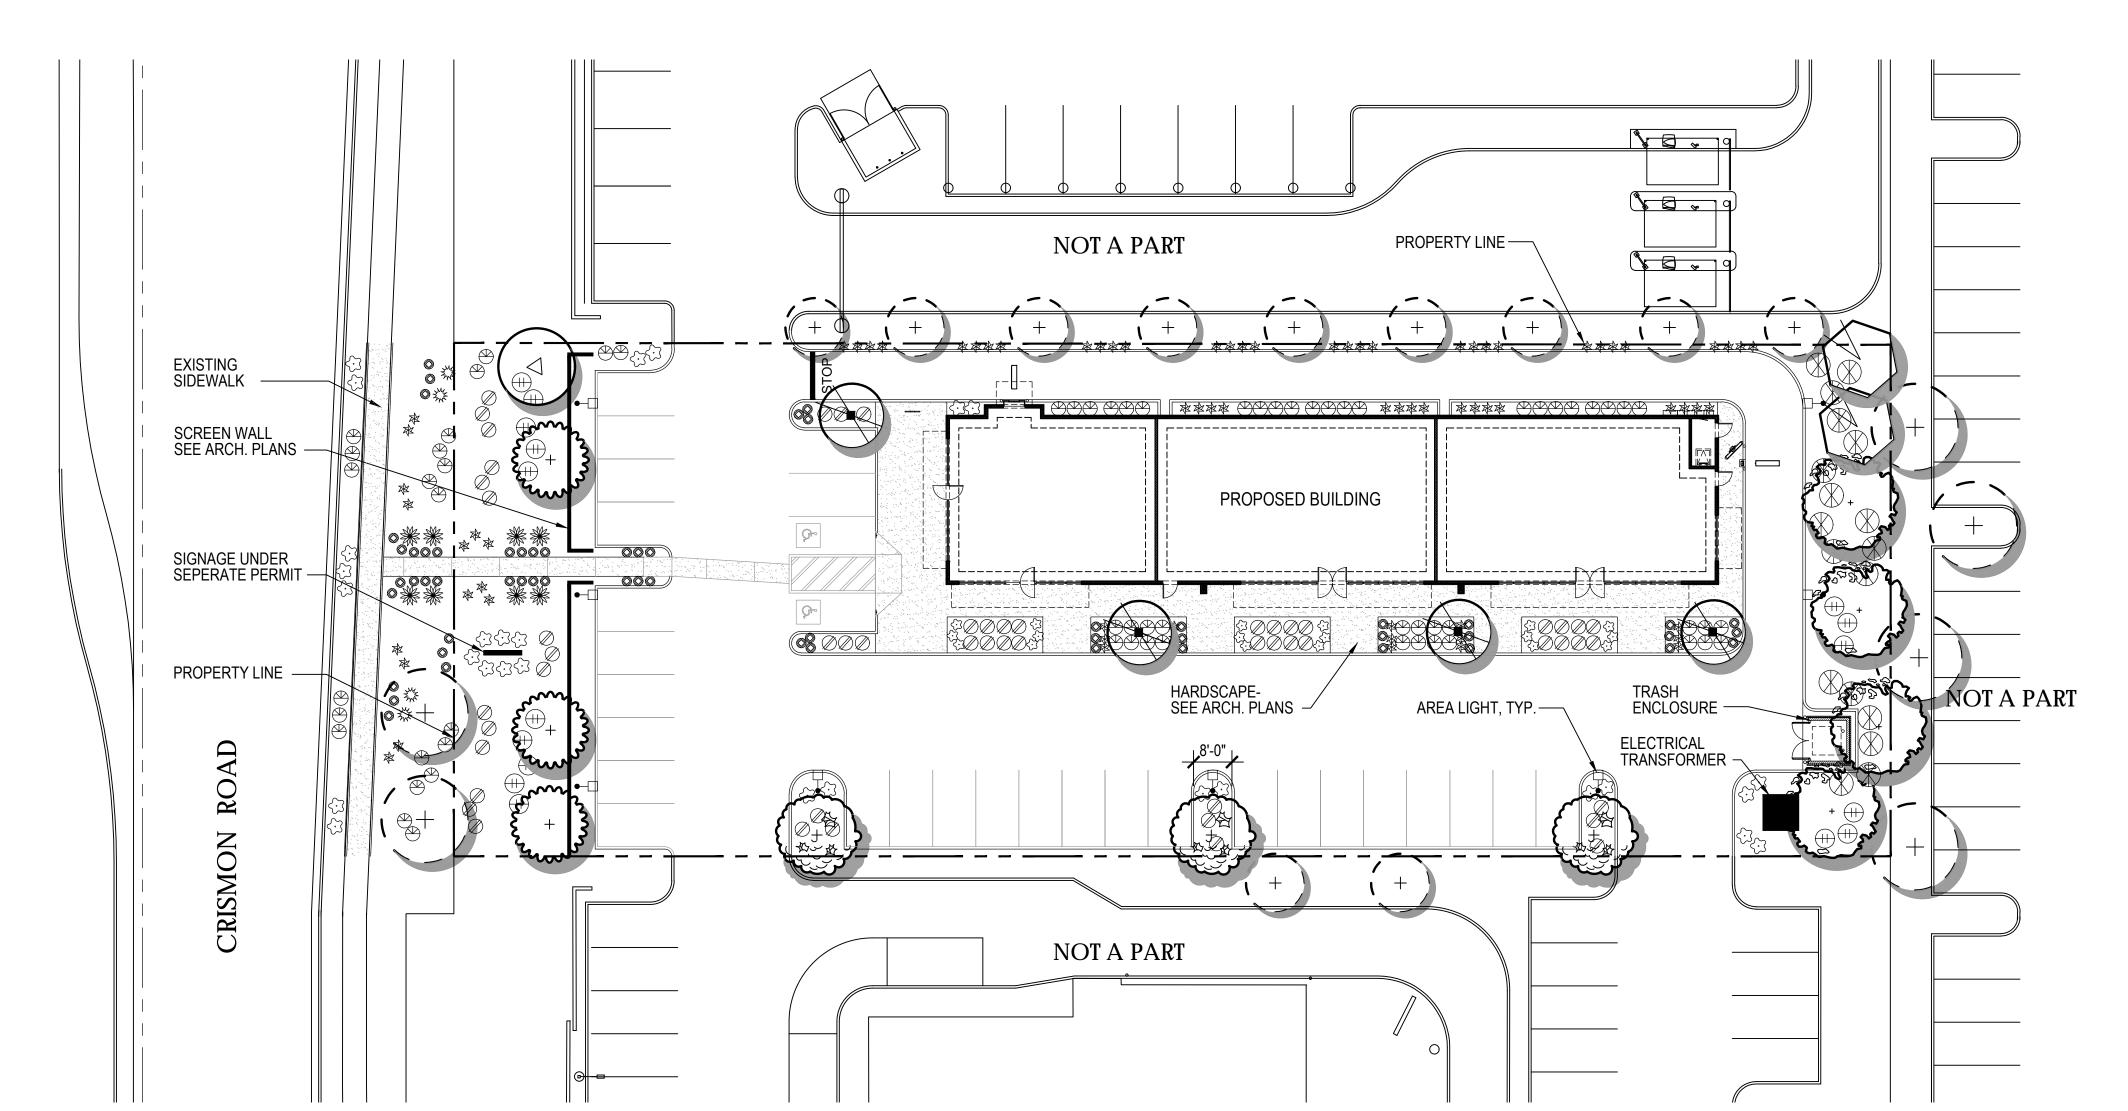

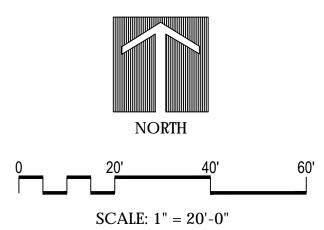

PLANTIEGEND

SYMBOL	BOTANICAL NAME	COMMON NAME	SIZE	
\	TREES		SIZE	
+	EXISTING TREE	VARIES- TO REMAIN	VARIES- TO REMAIN	
# 2 # # 2	4" ACACIA SALICINA	WILLOW ACACIA	15 GAL./ 24" BOX	
	ACACIA WILLARDIANA	PALO BLANCO	24" BOX	
36"	CAESALPINIA CACALACO 'SMOOTHIE'	THORNLESS CASCALOTE	24" BOX/ 36" BOX	
+	PARKINSONIA PRAECOX	PALO BREA	24" BOX	
	SHRUBS			
Ø	EREMOPHILA HYGROPHANA	BLUE BELLS	5 GAL.	
	LEUCOPHYLLUM LAEVIGATUM	CHIHUAHUAN SAGE	5 GAL.	
	RUELLIA BRITTONIANA	BRITISH RUELLIA	5 GAL.	
	ACCENTS			
*	AGAVE DESMETTIANA	SMOOTH AGAVE	5 GAL.	
本	ALOE 'BLUE ELF'	BLUE ELF ALOE	1 GAL.	
TWE TWE	HESPERALOE PARVIFLORA	RED YUCCA	5 GAL.	
	MUHLENBERGIA CAPILLARIS	REGAL MIST	1 GAL.	
	GROUNDCOVER			
$\langle : \rangle$	LANTANA 'NEW GOLD'	NEW GOLD LANTANA	1 GAL.	
©	RUELLIA BRITTONIANA 'KATIE'	KATIE RUELLIA	1 GAL.	
	INERT GROUNDCOVER			
	DECOMPOSED GRANITE	TO BE SELECTED- MATCH	SITE TO THE SOUTH	

GENERAL REQUIREMENTS

SCALING PLANS FOR ACCURATE DIMENSIONING.

- THE WORK INCLUDES NEW SHELL BUILDING CONSTRUCTION, PER SQUARE FOOT CALCULATIONS AS NOTED ON THE TITLE SHEET. CONTRACT WILL INCLUDE CONSTRUCTING WALLS AND CEILINGS FINISHES, DETAILS & SPECIFICATIONS. SECURE AND PAY FOR GOVERNMENT FEES, LICENSES AND PERMITS.
 CONTRACTORS SHALL VISIT THE PREMISES DURING THE BID PROCESS AND SHALL FAMILIARIZE THEMSELVES WITH EXISTING CONDITIONS AND THE REQUIREMENTS OF THE PROJECT PRIOR TO DEVELOPING THEIR BID. MATERIAL QUANTITIES SHALL BE
- PRIOR TO BEGINNING THE WORK, VERIFY ALL EXISTING DIMENSIONS AND SQUARE FOOTAGES. NOTIFY THE OWNER AND ARCHITECT OF COMPLIANCE OR DISCREPANCIES, COMPARING THOSE DISCREPANCIES TO THE NUMBERS ON THE TITLE SHEET.
 CONTRACTORS SHALL TAKE CARE TO PROTECT ADJACENT AREAS FROM DUST AND DAMAGE DURING THE CONSTRUCTION PROCESS, AND SHALL CLEAN UP AFTER

BASED ON ACTUAL FIELD CONDITIONS AND MEASUREMENTS. DO NOT RELY ON

- THEMSELVES AT THE END OF EACH WORKING DAY.

 5. ALL RUBBISH AND TRASH SHALL BE REMOVED FROM THE PREMISES AND PROPERLY DISPOSED OF EACH DAY. NO RUBBISH SHALL BE LEFT IN THE PREMISES AFTER WORK
- IS COMPLETED EACH DAY.

 6. ALL DRAWINGS HEREIN CREATE AN ENTIRE PACKAGE. ALL TRADES SHALL BE RESPONSIBLE FOR REVIEWING THEIR RESPECTIVE REQUIREMENTS AND COORDINAT-
- ING THEIR HIDDEN OR EXPOSEDWORK WITH OTHER RELATED. TRADES.
 7. COORDINATE ALL WORK OF THE VARIOUS TRADES AND SUBCONTRACTORS TO
 ASSURE EFFICIENT AND ORDERLY INSTALLATION. PROVIDE ACCOMMODATION FOR
 ITEMS INSTALLED AT A LATER DATE. VERIFY THAT CHARACTERISTICS OF ELEMENTS
 OF INTERRELATED OPERATING EQUIPMENT ARE COMPATIBLE; COORDINATE WORK OF
 VARIOUS SECTIONS WHICH HAVE INTERDEPENDENT RESPONSIBILITIES FOR INSTALLING, CONNECTING TO, AND PLACING IN SERVICE, SUCH EQUIPMENT.COORDINATE

SPACE REQUIREMENTS AND INSTALLATION OF MECHANICAL AND ELECTRICAL WORK

DIAGRAMMATICALLY ONDRAWINGS.

8. UNLESS SPECIFICALLY NOTED, PROVIDE AND PAY FOR LABOR, MATERIALS AND EQUIPMENT, TOOLS, CONSTRUCTION EQUIPMENT AND MACHINERY, AND OTHER FACILITIES AND SERVICES NECESSARY FOR PROPER EXECUTION AND COMPLETION OF WORK, INCLUDING PERMITS. UTILITIES SHALL BE PROVIDED BY OWNER.

AND FIRE SPRINKLER SYSTEM WHICH ARE INDICATED, DETAILED, OR IMPLIED

- GENERAL CONTRACTOR SHALL PURCHASE AND MAINTAIN INSURANCE COVERAGE IN ACCORDANCE WITH THE REQUIREMENTS OF THE LANDLORD AND THE TENANT. VERIFY AND COORDINATE WITH THE TENANT FOR ANY ADDITIONAL REQUIREMENTS.
 FURNISH ALL REQUIRED TEMPORARY FACILITIES AND ALL TEMPORARY UTILITIES IMMEDIATELY AFTER RECEIPT OF NOTICE TO PROCEED FOR USE IN CONVENIENCE OF
- ALL THOSE ENGAGED IN THE PROJECT WORK.

 11. ALL CONTRACTORS MUST STAY BEHIND THE BARRIERS AND MAINTAIN ACCESS TO SUCH AREAS CLEAN AND FREE OF CONSTRUCTION MATERIALS AND DEBRIS. FAILURE TO MAINTAIN CLEAN STOREFRONT WILL RESULT IN BUILDING MANAGEMENT HAVING SUCH MATERIALS AND DEBRIS REMOVED AND ALL CHARGES FOR MAINTENANCE WILL BE BILLED TO GENERAL CONTRACTOR.
- BE BILLED TO GENERAL CONTRACTOR.

 12. COORDINATE ALL CONSTRUCTION AND SCHEDULING WITH THE LANDLORD REVIEWING ALL SCHEDULED ACTIVITIES AT OUTSET OF CONSTRUCTION.
- 13. ALLOWABLE TOLERANCES UNLESS OTHERWISE NOTED OR INDICATED. THE FOLLOWING TOLERANCES SHALL APPLY TO ALL WORK:

 A. ALL VERTICAL SURFACES SHALL BE PLUMB OR CONSTRUCTED TO THE EXACT
- SLOPES OR ANGLES INDICATED.

 B. THE MAXIMUM DEVIATION FROM THE TRUE PLANE FOR VERTICAL AND HORIZONTAL SURFACES SHALL NOT BE GREATER THAN 1/8" IN 10'-0" AS
- MEASURED BY A STRAIGHT EDGE PLACED ANYWHERE ON THE SURFACE
 C. ALL HORIZONTAL SURFACES SHALL BE LEVEL OR CONSTRUCTED TO THE EXACT ANGLE INDICATED OR INTENDED.
- D. WALL AND SOFFIT INTERSECTIONS SHALL BE 90° OR THE EXACT ANGLE INDICATED OR INTENDED.
- E. ALL CORNERS AND EDGES SHALL BE STRAIGHT AND TRUE WITHOUT DENTS, WAVES OR BULGES OR OTHER BLEMISHES.
- F. ALL JOINTS SHALL BE TIGHT, STRAIGHT, EVEN AND SMOOTH. ALL OPERABLE ITEMS SHALL OPERATE SMOOTHLY WITHOUT STICKING OR BINDING AND WITHOUT EXCESSIVE "PLAY" OR LOOSENESS.

 14. THE FOLLOWING MATERIALS SHALL BE LEFT AT JOBSITE. THEY SHALL BE TAKEN
- 14. THE FOLLOWING MATERIALS SHALL BE LEFT AT JOBSITE. THEY SHALL BE TAKEN FROM THE SAME MATERIAL, LOT OR RUN USED TO CONSTRUCT AND FINISH THE PROJECT:
 A. ONE FULL GALLON OF EACH PAINT COLOR IN A CLEAN, TIGHTLY CLOSED CAN,
- AND CLEARLY MARKED.

 B. ONE FULL BOX OF EACH CERAMIC FLOOR TILE FREE FROM NICKS, SCRATCHES OR CRACKS.

 C. ONE-HALF BAG OF TILE GROUT.
- MATERIALS SHALL BE LEFT IN ONE LOCATION UPON OWNER'S REPRESENTATIVE'S DIRECTION AND APPROVAL.

 15. THE OWNER OR THE OWNER'S SUBCONTRACTORS MAY OCCUPY PORTIONS OF THE PROJECT
- 15. THE OWNER OR THE OWNER'S SUBCONTRACTORS MAY OCCUPY PORTIONS OF THE PROJECT DURING THE FINAL STAGE OF CONSTRUCTION. COORDINATE AND COOPERATE WITH THE OWNER TO MINIMIZE CONFLICT AND FACILITATE THE OWNER'S OPERATION.
- 16. ALL DIMENSIONS AND FINISHES SHALL BE VERIFIED AND COORDINATED WITH EXISTING CONDITIONS PRIOR TO CONSTRUCTION, FABRICATION, OR PURCHASING. IN CASE OF CONFLICT BETWEEN THE PROJECT REQUIREMENTS AND/OR EXISTING CONDITIONS, THE ONE HAVING THE MOST STRINGENT REQUIREMENTS SHALL GOVERN, AS APPROVED BY THE OWNER.
- AS APPROVED BY THE OWNER.

 17. PERFORM ALL WORK IN ACCORDANCE WITH ACCEPTABLE TRADE PRACTICE TO INSURE THE HIGHEST QUALITY FINISHED PRODUCT, EXPRESSED OR IMPLIED. PERFORM ALL WORK BY SKILLED MECHANICS IN ACCORDANCE WITH ESTABLISHED STANDARDS OF WORKMANSHIP IN EACH OF THE MADICINE TRADES.
- WORKMANSHIP IN EACH OF THE VARIOUS TRADES.

 18. COORDINATE BLOCKING REQUIREMENTS WITH ADJACENT OR RELATED TRADES,
 ACCESSORIES, EQUIPMENT AND FIXTURES INSTALL REQUIRED BLOCKING AT NO
 ADDITIONAL COST TO THE CONTRACT.
- 19. REPAIR PROPERTY DAMAGE BY THE INSTALLERS TO A LIKE NEW CONDITION OR REPLACE DAMAGED SURFACE AND MATERIALS OF THE PREVIOUSLY INSTALLED WORK BY OTHER TRADES, INSTALLERS AND SUBCONTRACTORS.
- 20. WHERE REQUESTED BY THE OWNER TO CERTIFY CONFORMANCE TO TRADE STANDARDS OR THE PROJECT REQUIREMENTS, THE CONTRACTOR SHALL ENLIST A TESTING LABORATORY AT THE OWNER'S COST. IF THE REQUESTED TEST SHOWN NON-CONFORMANCE TO GENERALLY ACCEPTED TRADE STANDARDS OR THE PROJECT REQUIREMENTS, THE CONTRACTOR SHALL CORRECT THE DEFICIENCY AT NO ADDITIONAL COSTS TO THE OWNER AND REIMBURSE ALL THE COSTS OF THE TESTING TO THE OWNER, UNLESS THE

CONTRACTOR HAS USED PRODUCTS INCORRECTLY LABELED BY THE MANUFACTURER OR

- HAS MADE PREVIOUSLY APPROVED CHANGES.
 21. PROVIDE SECURITY OF THE WORK, INCLUDING TOOLS AND UNINSTALLED MATERIALS.
 PROTECT THE WORK, STORED PRODUCTS, CONSTRUCTION EQUIPMENT AND OWNER'S PROPERTY FROM THEFT AND VANDALISM AND THE PREMISES FROM ENTRY BY UNAUTHORIZED PERSONNEL UNTIL ACCEPTANCE BY OWNER.
- 22. MAINTAIN AN ACTIVE FIRE EXTINGUISHER AT THE PROJECT.
 23. DO NOT USE MATERIAL OR EQUIPMENT FOR ANY PURPOSE OTHER THAN THAT FOR WHICH IT IS SPECIFICALLY DESIGNED OR SPECIFIED. ALL MATERIALS AND EQUIPMENT THAT ARE SIMILAR SHALL BE THE SAME TYPE, MODEL AND STYLE FOR THE SAME USE THROUGHOUT THE PROJECT OR THEY SHALL BE REJECTED.
- 24. WHEN THE PROJECT REQUIREMENTS REQUIRE THAT THE INSTALLATION OF WORK SHALL COMPLY WITH MANUFACTURER'S INSTRUCTIONS, PERFORM THE WORK IN STRICT ACCORDANCE WITH THE MOST CURRENT WRITTEN MANUFACTURER'S INSTRUCTIONS.
 25. ALL PRODUCTS AND EQUIPMENT SHALL BE DELIVERED IN UNDAMAGED CONDITION AND STORED IN ACCORDANCE WITH MANUFACTURER'S INSTRUCTIONS TO AVOID DISRUPTION OF THE WORK OR DAMAGE TO THE ITEMS. REPLACE DAMAGED OR UNFIT MATERIALS,
- AT NO COST TO THE OWNER.

 26. NOTIFY THE OWNER WHEN THE WORK IS SUBSTANTIALLY COMPLETE AND READY FOR INSPECTION. UPON INSPECTION, PROVIDE WRITTEN OPERATION AND MAINTENANCE INSTRUCTIONS AND GUARANTEES FOR ALL EQUIPMENT AND MATERIALS INSTALLED. PROVIDE WRITTEN GUARANTEES FOR A PERIOD OF ONE (1) YEAR FROM THE DATE OF
- FINAL ACCEPTANCE OF THE WORK.

 27. PROVIDE FINAL CLEAN-UP AND DAMAGE REPAIR AT THE PROJECT CONCLUSION. LEAVE THE PREMISES NEAT, CLEAN AND CLEAR OF TOOLS, EQUIPMENT AND SURPLUS MATERIALS, UNLESS REQUESTED BY THE OWNER. CLEAN-UP SHALL INCLUDED AND NOT BE LIMITED TO:
- A. POWER VACUUMING THE ENTIRE SPACE.
 B. REPAIR OR REPLACEMENT OF PROPERTY DAMAGED DURING FINAL COMPLETION OF THE PROJECT.

DEMOLITION / BUILDING ALTERATIONS

- 1. THE WORK MAY INCLUDE DEMOLITION OF EXISTING CONSTRUCTION, REMOVAL OF VARIOUS ITEMS OF EQUIPMENT AND CONSTRUCTION, AND THE CUTTING OR ALTERATION OF EXISTING CONSTRUCTION AS SHOWN. NOTED OR IMPLIED ON THE DRAWINGS. CONTRACTOR SHALL DETERMINE AND INVENTORY ALL NECESSARY DEMOLITION AND ALTERATION OF ITEMS TO PROVIDE FOR A COMPLETE INSTALLATION OF NEW WORK. ALL COSTS OF REMOVAL REPAIR OR REPLACEMENT SHALL BE INCLUDED IN THE BID. ADDITIONAL COSTS FOR DEMOLITION OF ITEMS HIDDEN OR INACCESSIBLE DURING THE BIDDING PHASE, SHALL BE SUBMITTED FOR APPROVAL PRIOR TO BEGINNING THE WORK.
- 2. AT ALTERED CONSTRUCTION REPAIR CUT EDGES, REPLACE CONSTRUCTION. AND FIT NEW TO EXISTING CONSTRUCTION TO MATCH EXISTING WORK, MAKE JOINTS OF NEW AND EXISTING PATCHES VERY SMOOTH, EVEN AND PRACTICALLY INVISIBLE. COORDINATE ALL REPLACEMENT AND REPAIR REQUIREMENTS WITH LANDLORD'S CONSTRUCTION CRITERIA AND TENANTS COORDINATOR.

 SAW-CUT CONCRETE ON GRADE WITH DIAMOND SAW; JACKHAMMERING WILL NOT BE PERMITTED EXCEPT WITH THE EXPRESSED WRITTEN APPROVAL OF THE LANDLORD. CUT IN ACCURATELY LOCATED STRAIGHT LINES AND BREAK OUT SECTIONS. FLOOR MAY BE CORE DRILLED WHERE APPROPRIATE FOR INSTALLATION OF PIPES AND SIMILAR ITEMS. COORDINATE ALL CORE LOCATIONS AND SLAB MODIFICATIONS WITH LANDLORD'S STRUCTURAL ENGINEER. WHERE EXISTING PIPING AND OTHER SIMILAR ITEMS ARE UNDER EXISTING SLABS, EXERCISE CARE TO PROTECT FROM DAMAGE EXERCISE CARE WHEN CUTTING ADJACENT TO EXISTING WALLS TO AVOID DAMAGE TO WALLS IF DAMAGED. REPAIR AS REQUIRED TO ORIGINAL CONDITION. DO NOT CUT
- SUSPENDED SLAB EXCEPT AS NOTED ON DRAWINGS.

 4. DOORS AND FRAMES: IF DOORS AND FRAMES ARE TO BE REUSED ON THE WORK, CAREFULLY REMOVE DOOR FROM FRAMES AND REMOVE FRAMES FROM OPENING, TAKING CARE TO AVOID DAMAGE REMOVE HARDWARE, CLEAN REFURBISH, AND STORE FOR REINSTALLATION WHERE INDICATED FOR DOORS AND FRAMES TO BE SALVAGED, CAREFULLY REMOVE FROM OPENING AND DELIVER FOR STORAGE WHERE INDICATED.

- 5. PREVENT MOVEMENT OR SETTLEMENT OF STRUCTURE. PROVIDE AND PLACE BRACING AND SHORING AND BE RESPONSIBLE FOR SAFETY AND SUPPORT OF STRUCTURE, AS DETERMINED BY G.C. ENLISTED STRUCTURAL ENGINEER. ASSUME LIABILITY FOR SUCH MOVEMENT, SETTLEMENT DAMAGE OR INJURY.
- SUCH MOVEMENT, SETTLEMENT DAMAGE OR INJURY.

 6. ARRANGE AND PAY FOR DISCONNECTING, REMOVING AND CAPPING UTILITY SERVICES WITHIN AREAS AFFECTED BY DEMOLITION. PLACE MARKERS TO INDICATE LOCATION OF DISCONNECTED SERVICES. WHERE APPLICABLE, LOCATE SPRINKLER SHUT-OFF VALVE AND SMOKE ALARM PRIOR TO COMMENCING WORK; COORDINATE REQUIRED MODIFICATION WITH LANDLORD.
- 7. CAREFULLY REMOVE MATERIALS AND EQUIPMENT WHICH ARE INTENDED TO BE REUSED. STORE IN A SECURE LOCATION. REMOVE DEBRIS, REFUSE AND MATERIALS BEING
- DEMOLISHED IMMEDIATELY FROM THE SITE.

 8. ERECT AND MAINTAIN WEATHERPROOF AND DUSTPROOF CLOSURES AND PARTITIONS TO PREVENT WEATHER DAMAGE OR SPREAD OF DUST, FUMES AND SMOKE TO OTHER PARTS OF THE BUILDING, IN ACCORDANCE WITH GUIDELINES AND STIPULATIONS OF LOCAL AUTHORITIES & LANDLORD.
- PERFORM DEMOLITION IN ACCORDANCE WITH APPLICABLE AUTHORITIES HAVING JURISDICTION.
- REPAIR ALL DEMOLITION IN EXCESS OF THAT REQUIRED AT NO COST TO THE OWNER.
 REMOVE FROM SITE CONTAMINATED, VERMIN INFESTED OR DANGEROUS MATERIALS ENCOUNTERED; DISPOSE OF BY SAFE MEANS TO PROTECT HEALTH OF WORKERS AND

CONCRETE REPAIR AND REPLACEMENT

- WORK INCLUDES PATCHED DEMOLISHED SLAB. IF ANY; FILLING AND LEVELING JOINTS AND CRACKS; AND FILLING ABANDONED ELECTRICAL BOXES AND ANY HOLES GREATER THAN 1/2".
- 2. USE RAECO-LITH "r-35" AS UNDERLAYMENT FOR PATCHING OR APPROVED EQUAL MIX SHALL BE TWO PARTS MORTAR MIX AND LATEX BINDER MIX AND INSTALL PER MANUFACTURER'S LATEST WRITTEN AND RECOMMENDED DIRECTIONS.

WOOD AND PLASTICS

- 1 ROUGH CARPENTRY
- A. PROVIDE ROUGH LUMBER AND PLYWOOD IN STANDARD DIMENSIONS. MOISTURE CONTENT NOT MORE THAN 19%, WITH THE INDICATION OF "S-DRY" ON THE
- B. ALL LUMBER IS TO BE GRADE STAMPED AND IS TO CONTAIN GRADING AGENCY,
 MILL NUMBER OR NAME, GRADE OR LUMBER SPECIES OR SPECIES GROUPING
 COMBINATION DESIGNATION BUILES LINDER WHICH GRADED WHERE APPLICABLE
- COMBINATION DESIGNATION, RULES UNDER WHICH GRADED, WHERE APPLICABLE.

 C. LUMBER SHALL BE PROTECTED FROM THE ELEMENTS UNTIL SUCH TIME IT IS USED IN CONSTRUCTION.
- D. INSTALL ROUGH CARPENTRY WORK TO COMPLY WITH APPLICABLE CODE STANDARDS UNLESS OTHERWISE INDICATED. FOR SHEATHING UNDERLAYMENT AND OTHER PRODUCTS NOT COVERED IN ABOVE STANDARDS, COMPLY WITH RECOMMENDATIONS OR MANUFACTURER OF PRODUCT INVOLVED FOR USE INTENDED. SET CARPENTRY WORK TO REQUIRED LEVELS AND LINES, WITH MEMBERS PLUMB AND TRUE AND
- E. SECURELY ATTACH CARPENTRY WORK TO SUBSTRATES AND SUPPORTING MEMBERS USING FASTENERS OF SIZE THAT WILL NOT PENETRATE MEMBERS WHERE OPPOSITE SIDE WILL BE EXPOSED TO VIEW OR RECEIVE FINISH MATERIALS. INSTALL FASTENERS WITHOUT SPLITTING WOOD, FASTEN PANEL PRODUCTS TO ALLOW FOR EXPANSION
- AT JOINTS UNLESS OTHERWISE INDICATED.

 F. PROVIDE WOOD FRAMING MEMBERS OF SIZE AND SPACING INDICATED. DO NOT SPLICE STRUCTURAL MEMBERS BETWEEN SUPPORTS. FIRESTOP CONCEALED SPACES WITH WOOD BLOCKING NOT LESS THAN 2" THICK, IF NOT BLOCKED BY OTHER FRAMING MEMBERS. PROVIDE BLOCKING WHERE REQUIRED FOR ANCHORAGE OF CASE WORK,
- ACCESSORIES, AND ELSEWHERE AS REQUIRED.

 2. PROVIDE ALL NECESSARY ROUGH HARDWARE IN SIZES AND QUANTITIES REQUIRED BY LOCAL CODE OR APPROVED BY ARCHITECT.
- 3. USE FINISH OR CASING NAILS FOR EXPOSED WORK; USE TYPE "S" TRIM HEAD SCREWS FOR ATTACHMENT OR WOOD TRIM TO METAL STUDS, RUNNERS OR FURRING.

 4. PELIFICE BACKS OF WOOD TRIM: KEDE BACKS OF MEMBERS MODE THAN 5" WIDE AND 1"
- 4. RELIEVE BACKS OF WOOD TRIM; KERF BACKS OF MEMBERS MORE THAN 5" WIDE AND 1'
 NOMINAL THICKNESS; EASE ALL EXTERNAL CORNERS.

 5. INSTALL LAMINATES ONLY WHEN RECEIVING SURFACES ARE IN A SATISFACTORY.
- 5. INSTALL LAMINATES ONLY WHEN RECEIVING SURFACES ARE IN A SATISFACTORY CONDITION FOR INSTALLATION.

 6. USE ADHESIVES RECOMMENDED BY THE MANUFACTURER FOR THE PARTICULAR
- APPLICATION: INSTALL IN ACCORDANCE WITH MANUFACTURER'S MOST CURRENT PRINTED APPLICATION INSTRUCTIONS.

 7. PROTECT FROM DAMAGE BY OTHER TRADES WORKING ADJACENT TO THE INSTALLATION.
- REPLACE DAMAGED SURFACES.

 8. REMOVE EXCESS ADHESIVE AND CLEAN SURFACES USING MANUFACTURER'S RECOMMENDED SOLVENT AND CLEANING PROCEDURES.
- SOLVENT AND CLEANING PROCEDURES.

 9. FILL IN ALL SEAMS WITH MANUFACTURER'S APPROPRIATE COLOR SEAM COMPOUND.

 10. INSTALL WOODS AND PLASTICS IN CONFORMANCE WITH DETAILS, WITH THE FOLLOWING CONSIDERATIONS AND REQUIREMENTS:
- A. INSTALL ALL MATERIAL WITH TIGHT JOINTS.

 B. MITER CASINGS, MOLDING, BASE AND STOREFRONT LAMINATED OR PAINTED MDF
- C. ALL RUNNING TRIM ONE (1) PIECE UP TO 10' 0". MATCH GRAIN AND
- D. USE FINISH NAILS EXCEPT WHERE SCREWS ARE SPECIFICALLY CALLED FOR OR WHERE SCREWS DO NOT SHOW.
- E. SET FASTENERS FOR PUTTYING.
 F. WHERE SCREW ATTACHMENT REQUIRED, SPACE SCREWS AT EQUAL INTERVALS; SINK AND PUTTY IN FINISH WOOD SURFACES.
- G. ALL MEMBERS AND LINES LEVEL AND PLUMB.
 H. SELECT AND CUT MATERIAL TO EXCLUDE DAMAGED, MARKED, OR DEFECTIVE AREAS.
- FINISH EXPOSED SURFACES SMOOTH, FREE FROM TOOL AND MACHINE MARKS.
 EASE ALL EXPOSED WOOD EDGES 1/8" MINIMUM RADIUS.
 INSTALL FIRE RATED DOORS IN ACCORDANCE WITH REQUIREMENTS OF NATIONAL FIRE PROTECTION ASSOCIATION (MERA). RECOMMENDATIONS.
- FIRE PROTECTION ASSOCIATION (NFPA) RECOMMENDATIONS.

 L. NON-COMB. FIRE TREATED WOOD BEARING FACTORY IMPREGNATED STAMP SHALL BE USED FOR ALL WOOD FRAMING MEMBERS OF EXPOSED WOOD FINISHES TO BE FIRE RETARDANT TREATED UNLESS NOTED OTHERWISE.

SEALANTS AND CAULKING/ ROOF PATCHING AND SOUND ATTENUATION BATT INSULATION

- 1. PROVIDE NON-SAG SEALANT COMPLYING WITH REQUIREMENTS OF FEDERAL SPECIFICATIONS TTS-1543 OR FS TT-S 230 TYPE "II", CLASS "a". PROVIDE ACOUSTICAL SEALANT WHICH SHALL BE NON-HARDENING, NON-DRYING SYNTHETIC RUBBER SEALING COMPOUND WITH MINIMUM 90% SOLIDS. USE AT ALL INTERIOR JOINTS AT INNER SECTIONS BETWEEN PLANES. AROUND DOOR AND WINDOW FRAMES PRIMER SHALL BE MADE OR RECOMMENDED BY SEALANT MANUFACTURER FOR THE
- SPECIFIC CONDITIONS AND SUBSTRATES.

 2. PROVIDE BACKING MATERIAL BY DOW "ETHAFOAM" OR APPROVED EQUAL. APPLY SEALANT OVER BACKING TO UNIFORM THICKNESS IN CONTINUOUS BEADS FILLING ALL JOINTS AND VOIDS SOLID. SUPERFICIAL POINTING WITH THE SKIM BEAD WILL NOT BE ACCEPTED.
- 3. ALL SURFACES SHALL BE ADEQUATELY CLEANED AND PREPARED IN ACCORDANCE WITH MANUFACTURER'S WRITTEN INSTRUCTIONS PRIOR TO INSTALLATION.
- 4. FURNISH ALL LABOR, MATERIALS, TOOLS, EQUIPMENT AND SCAFFOLDING REQUIRED FOR COMPLETING BUILT UP ROOFING FLASHING AND ASSOCIATED SHEET METAL WORK AND RELATED ITEMS INDICATED ON THE DRAWINGS AND SPECIFIED HEREIN. (NOTE: REFER TO DRAWINGS FOR ITEMS APPLICABLE TO THE PROJECT)
- ALL MATERIALS INCLUDING FELTS, COMPOSITION FLASHING, BITUMEN, ROOF INSULATION, VAPOR RETARDER, (IF ANY), AGGREGATE SURFACING OR OTHER COATING, ETC. IS TO BE COMPATIBLE W/EXIST. ROOFING SYSTEM TO COMPLETE THE PATCHING OF THE EXIST. ROOF
- COORDINATE THIS WORK WITH OTHER TRADES INVOLVED TO AVOID DELAYS AND TO INSURE A SATISFACTORY AND WATERTIGHT INSTALLATION.
 INSTALL ALL REQUIRED MATERIALS IN A PROPER MANNER TO INSURE A WATERTIGHT AND WEATHERPROOF INSTALLATION.
- 5. SOUND ATTENUATION BATT INSULATION PROVIDE "OWENS CORNING" SOUND ATTENUATION BATT INSULATION AT ALL PERIMETER WALLS OR TOILET ROOMS FULL HEIGHT OF WALLS. INSULATION SHALL BE 3 1/2" THICK FRICTION FIT INSTALLATION FOR 24" STUD SPACING. CUT AS REQUIRED FOR UTILITIES IN WALLS.

WOOD AND HOLLOW METAL DOORS AND FRAMES

- PROVIDE KD TYPE WELDED METAL DOOR FRAMES AT ALL G.C. PROVIDED DOORS, AS DETAILED FREE FROM SCALE AND PITTING AND OTHER SURFACE DEFECTS, UNLESS OTHERWISE NOTED.
- NOTED.

 2. PROVIDE HOLLOW METAL DOOR AS REQUIRED ON PLANS CONSTRUCTED WITH THE FOLLOWING MATERIAL
- A. MINIMUM 18. GA. FOR FACE SHEETS OF INTERIOR DOORS.
 B. 16 GA. FOR EDGE CHANNELS.
- C. MINIMUM 22 GA. FOR FACE STIFFENERS.
 D. MINIMUM 16. GA. FOR INTERIOR FRAMES.
 3. PROVIDE DOORS OF SIZES AND TYPES INDICATED ON DRAWINGS, FULLY WELDED
 SEAMLESS CONSTRUCTION WITH NO VISIBLE SEAMS OR JOINTS ON FACES OR VER
- SEAMLESS CONSTRUCTION WITH NO VISIBLE SEAMS OR JOINTS ON FACES OR VERTICAL EDGES; THICKNESSES AS SCHEDULED ON DRAWINGS.

 4. FACE STIFFENERS, EDGES AND HARDWARE REINFORCEMENT SHALL BE THE HIGHEST
- QUALITY WORKMANSHIP AND MATERIALS. PROVIDE IN ACCORDANCE WITH BEST TRADE PRACTICE AND MANUFACTURER'S WRITTEN RECOMMENDATIONS FOR THE USE INTENDED.

 5. PROVIDE CUSTOM MADE WELDED UNITS WITH INTEGRAL TRIM: SIZES AND SHAPES AS
- PROVIDE CUSTOM MADE WELDED UNITS WITH INTEGRAL TRIM; SIZES AND SHAPES AS
 INDICATED ON DRAWINGS; FABRICATE UNITS SQUARE, TRUE AND FREE FROM DEFECTS.
 HARDWARE REINFORCEMENT AND ANCHORS (ERECTION, FLOOR AND JAMB) SHALL BE AS
- REQUIRED FOR A SECURE INSTALLATION AND SHALL BE IN ACCORDANCE WITH TRADE REQUIREMENTS FOR THE SPECIFIED HARDWARE AND INTENDED USE.

 7. AFTER FABRICATION, DRESS, FILL AND SAND EXPOSED SURFACES, BODY-PUTTY HOLES AND IMPERFECTIONS. APPLY UNIFORM COAT OF MANUFACTURER'S STANDARD PRIME
- COAT TO ALL EXPOSED SURFACES. LEAVE READY TO RECEIVE FINISH PAINTING.

 8. NSTALL FRAMES IN ACCURATE LOCATIONS AS INDICATED ON DRAWINGS. INSTALL RIGID, PLUMB, LEVEL AND TRUE. ALIGN WITH ADJACENT CONSTRUCTION. SECURE FLOOR ANCHORS TO FLOOR CONSTRUCTION WITH APPROVED TYPE MECHANICAL FASTENINGS: ANCHOR TO ADJOINING WALLS WITH SPECIFIED ANCHORS. BRACE FRAMES TO RETAIN POSITION AND CONTINUOUSLY CHECK ALIGNMENT DURING CONSTRUCTION OF ADJACENT WALLS. ADJUST FRAME LOCATIONS AS NECESSARY USING SHIMS BEFORE FASTENING. LEAVE READY TO RECEIVE SEALANT WHERE INDICATED ON
- INSTALL WOOD DOORS, FRAMES, AND TRIM. SIZES AND THICKNESS AS SCHEDULED ON THE DRAWINGS.
 PREPARE DOORS FOR FINISH HARDWARE. OBTAIN TEMPLATES FROM HARDWARE MANUFACTURER AND CONFIRM TYPE, LOCATION, AND SPECIAL REQUIREMENTS OF HARDWARE FOR EACH DOOR PRIOR TO CUTTING.
 HANG DOORS AS SCHEDULED ON DRAWINGS, IN ACCURATE LOCATIONS WITH 1/8"
- HARDWARE FOR EACH DOOR PRIOR TO CUTTING.

 11. HANG DOORS AS SCHEDULED ON DRAWINGS, IN ACCURATE LOCATIONS WITH 1/8" CLEARANCE AT TOPS AND 3/8" CLEARANCE AT BOTTOM, UNLESS SPECIFICALLY NOTED FOR "UNDERCUTS" OR OTHER DEVIATIONS IN FIT. VERIFY CLEARANCES REQUIRED FOR CARPETING AND MAKE NO JOBSITE FIT IN CUTS UNLESS APPROVED. HANG PAIRS OF DOORS AS SPECIFIED WITH 3/32" CLEARANCE AT MEETING EDGES. DEMONSTRATE THAT DOORS OPEN FREELY WITHOUT BINDING, AND WHEN CLOSED, WILL LATCH PROPERLY.

FINISHES

DRAWINGS.

- METAL SUPPORT SYSTEM (WALL STUDS)

 1. PROVIDE CHANNEL-SHAPED ROLL FORMED SHEET STEEL MEMBERS CONFORMING WITH ASTM C645-00, HOT DIPPED FINISH WHERE EXPOSED TO MOISTURE NOT LESS THAN
- 20 GAUGE PROVIDE 16 GAUGE AT DOOR JAMBS AND AT STOREFRONT.
 PROVIDE COLD, ROLLED STEEL CHANNELS NOT LESS THAN 16 GAUGE.
 PROVIDE ROLL HAT-SHAPED CHANNELS MINIMUM 25 GAUGE, 7/8" DEEP WITH 1/2"
- HEMMED EDGES. HOT DIPPED FINISH WHERE NOTED.

 4. INTERIOR WALL CONNECTIONS TO EXIST. STRUCTURE ABOVE REFER TO DRAWINGS.

 5. DROVIDE LACK STUDS RETWEEN POTTOM TRACK AND WINDOW AND OR BELIEF SILLS.
- 5. PROVIDE JACK STUDS BETWEEN BOTTOM TRACK AND WINDOW AND/OR RELIEF SILLS BETWEEN LINTELS AND HEADERS IN TOP TRACKS.
 6. PROVIDE BLOCKING AND FRAMING FOR ALL WALL MOUNTED FINISH HARDWARE AND
- EQUIPMENT, INCLUDING DOOR STOPS.

 7. SET FLOOR TRACKS IN ACCURATE LOCATIONS AND SECURELY ANCHOR IN ACCORDANCE WITH ASTM STANDARDS. ERECT STUDS ON 16" OR 24" (AS INDICATED) CENTERS AND SECURE TO TRACK INSTALL HEAD TRACK IN ACCORDANCE WITH DETAILS. INSTALL
- WITH ASTM STANDARDS. ERECT STUDS ON 16" OR 24" (AS INDICATED) CENTERS AND SECURE TO TRACK. INSTALL HEAD TRACK IN ACCORDANCE WITH DETAILS. INSTALL BLOCKING, BRACING, AND ANCHOR STRIPS. LEAVE READY TO RECEIVE FINISH MATERIALS.

 8. ERECT ALL COMPONENTS FOR CEILING AND SOFFIT FRAMING IN ACCURATE LOCATIONS
- AS INDICATED. TRUE TO LINE, LEVEL AND PLUM, AND IN ACCORDANCE WITH APPLICABLE ASTM STANDARDS AS REFERENCED ABOVE, USING A LASER LEVEL. ADJUST SUPPORTS, SPANS OR OTHERWISE FOR INSTALLATION WITHIN SPECIFIED TOLERANCES.
- 9. PROVIDE KICK BRACING IN ACCORDANCE WITH INDUSTRY STANDARDS FOR WALL STUDS, CEILING MEMBER, DRAFT OR SMOKE STOPS AND CURTAIN WALLS.
- FIBER REINFORCED PANELS (FRP)

 1. ALL PANELS SHALL HAVE A CLASS 1 FLAME SPREAD CLASSIFICATION INDEX OF LESS THAN 25. ALL PANELS SHALL BE MOISTURE RESISTANT AND SHALL NOT RUST OR CORRODE. PROVIDE ALL TRIM AND ACCESSORIES AS REQUIRED FOR A COMPLETE INSTALLATION AS INDICATED AND SPECIFIED HEREIN. COLOR OF PANELS, TRIM AND
- ACCESSORIES SHALL BE WHITE.

 2. FOLLOW MANUFACTURER'S RECOMMENDED INSTALLATION PROCEDURES FOR ALL PREFINISHED PANEL AS SCHEDULED.
- PREFINISHED PANEL AS SCHEDULED.

 3. PANELS SHALL BE INSTALLED IN A VERTICAL POSITION IN FULL LENGTH UNITS.

 4. APPLY RECOMMENDED ADHESIVE TO BACK OF PANEL TO PROVIDE 100% COVERAGE WITH V-NOTCH SPREADER. MITER CUT MOLDINGS AND TRIM PIECES AT CORNERS
- AND INTERSECTIONS AS REQUIRED TO PROVIDE SMOOTH TRANSITION.

 5. UPON COMPLETION OF WORK, SURFACES OF PANELS AND COMPONENTS SHALL BE CLEANED IN ACCORDANCE WITH MANUFACTURER'S RECOMMENDATIONS AND LEFT FREE FROM DEFECTS, COMPONENTS THAT ARE DAMAGED OR IMPROPERLY INSTALLED SHALL BE REMOVED AND REPLACED WITHOUT ADDITIONAL COST TO THE OWNER.
- PAINTING

 1. PROVIDE PAINT FINISHES FOR BUILDING AND OTHER SURFACES AS SCHEDULED ON DRAWINGS OR AS SPECIFIED HEREINAFTER INCLUDING SEALING OF CONCRETE FLOOR NO PAINT FINISH IS REQUIRED ON ITEMS HAVING COMPLETE FACTORY FINISH, EXCEPT AS MAY BE SPECIFIED HEREINAFTER; PUTTY AND/OR SEALANT AT ALUMINUM WINDOWS NON-FERROUS METAL UNLESS SPECIFICALLY MENTIONED IN THE FINISH SCHEDULE; STAINLESS STEEL; INTERIOR OR EXTERIOR OF EXISTING BUILDING, EXCEPT WHERE ALTERATIONS OCCUR OR WHERE SCHEDULED, EXCEPT WHERE EXPOSED IN
- NO PAINTING IS REQUIRED FOR INSULATED PIPING, EXCEPT WHERE EXPOSED IN FINISH, NON-MECHANICAL ROOM SPACES.

 2. PROTECT WORK OF OTHER TRADES FROM DAMAGE AND DEFACEMENT CAUSED BY THIS WORK. REPAIR ANY DAMAGE CAUSED BY THE WORK OF THIS SECTION. REMOVE ELECTRICAL OUTLET AND SWITCH PLATES, MECHANICAL DIFFUSSERS, GRILLES, ESCUTCHEONS, REGISTERS, SURFACE HARDWARE, FITTING, AND FASTENINGS PRIOR TO
- COMMENCING THE WORK. STORE, CLEAN, AND REPLACE UPON COMPLETION.

 3. PAINT CONTRACTOR SHALL NOTIFY THE GENERAL CONTRACTOR IF ANY SURFACE TO BE PAINTED OR STAINED IS FOUND TO BE UNSUITABLE TO PRODUCE PROPER FINISH. APPLY NO FINISH MATERIAL UNTIL THE UNSUITABLE SURFACES HAVE BEEN MADE SATISFACTORY.

 4. FINISH WORK SHALL BE UNIFORM, OF APPROVED COLOR, SMOOTH AND FREE FROM
- RUNS. MAKE ENDS OF PAINT ADJOINING OTHER MATERIALS OR COLORS SHARP AND CLEAN. WHERE HIGH GLOSS ENAMEL IS USED, LIGHTLY SAND UNDERCOAT TO OBTAIN A SMOOTH FINISH COAT.

 5. PROVIDE ALL NEWLY PAINTED SURFACES WITH (1) COAT TINTED PRIMER AND (2)
- PROVIDE ALL NEWLY PAINTED SURFACES WITH (1) COAT TINTED PRIMER AND (2)
 COATS FINAL COLOR COAT, UNLESS OTHERWISE RECOMMENDED BY MANUFACTURER'S
 SPECIFICATIONS.
 DELIVER ALL PAINT TO JOBSITE IN UNOPENED CONTAINERS BEARING THE
- MANUFACTURER'S LABEL AND SHOWING PAINT TYPE, SHEEN AND COLOR.

 7. PAINT TYPES USED SHALL BE THOSE SPECIFICALLY RECOMMENDED BY THE
 MANUFACTURER FOR THE MATERIAL TO WHICH THEY WILL BE APPLIED. PAINTING
 CONTRACTOR SHALL FOLLOW MANUFACTURER'S INSTRUCTIONS FOR PROPER APPLICATION
 OF THE PAINT.
- ALL SURFACES TO BE PAINTED SHALL BE THOROUGHLY CLEANED AND PREPARED FOR PAINTING PRIOR TO APPLICATION OF PAINT. PROVIDE VENTILATORS AS REQUIRED TO PREVENT BUILD-UP OF FUMES.
 SANDPAPER ALL NEW WOOD TO SMOOTH AND EVEN SURFACE AND DUST OFF. AFTER
- SANDPAPER ALL NEW WOOD TO SMOOTH AND EVEN SURFACE AND DUST OFF. AFTER
 PRIMING COAT HAS BEEN APPLIED, THOROUGHLY FILL ALL NAIL HOLES AN OTHER
 SURFACE IMPERFECTIONS WITH PUTTY TINTED WITH PRIMER OR STAIN TO MATCH WOOD
 COLOR. SAND ALL WOODWORK BETWEEN COATS TO A SMOOTH SURFACE.
 BACK PRIME ALL EXTERIOR AND INTERIOR WOOD AND TRIM PRIOR TO INSTALLATION.
- THOROUGHLY CLEAN SURFACES AND APPLY NO FINISH UNLESS SURFACES ARE DRY AND READY FOR APPLICATION. SANDPAPER SURFACES OF TRIM SMOOTH AND WIPE CLEAN. AFTER STAIN COAT HAS BEEN APPLIED, FILL CRACKS AND HOLES WITH PLASTIC WOOD OR PUTTY. IF STAIN HAS BEEN USED, TINT CRACK FILLER TO MATCH; PRIME BACKS OF TRIM, PRIME BARE WOOD SCHEDULED TO RECEIVE PAINT FINISH; FINISH NAIL HOLES, CRACKS AND OTHER IMPERFECTIONS WITH PUTTY AND SAND SMOOTH.
- HOLES, CRACKS AND OTHER IMPERFECTIONS WITH PUTTY AND SAND SMOOTH.

 11. AT COMPLETION, TOUCH-UP AND RESTORE FINISH WHERE DAMAGED AND LEAVE ALL SURFACES IN GOOD AND CLEAN CONDITION. PROVIDE FOR MULTIPLE SITE VISITS AS REQUIRED FOR TOUCH-UP AND REFINISHING.
- OTHER PAINT MANUFACTURER'S MAY NOT BE SUBSTITUTED WITHOUT APPROVAL OF ARCHITECT.
 FINISH INTERIOR SURFACES, AS SCHEDULED ON DRAWINGS, EXCEPT AS MODIFIED AND SUPPLEMENTED HEREINAFTER AND UPON WRITTEN OWNER APPROVAL. IN GENERAL, USE

EGSHELL FOR ALL INTERIOR FINISHES WITH THE EXCEPTION OF THE OF THE CEILING,

WHICH SHOULD BE FLAT. PLEASE REFER TO SHEET A-3 FOR COMPLETE FINISH SCHEDULE

GYPSUM WALL BOARD 1. PROVIDE GYPSUM WALL PANELS MANUFACTURED IN ACCORDANCE WITH REQUIREMENTS OF

- ASTM C36/C36M-01.
 2. PROVIDE TYPE "X" FIRE RETARDANT GYPSUM WALL BOARD PANELS 5/8" THICK, TESTED AND QUALIFIED FOR 1-HOUR RATING, TAPERED AND ROUNDED AT EDGES AS INDICATED
- ON DRAWINGS.

 3. PROVIDE METAL EDGE AND CORNER BEADS AT ENDS, EDGES AND CORNERS.

 4. WATER RESISTANT GYPSUM WALL BOARD SHALL BE 1/2" THICK, QUALIFIED FOR 1- HOUR RATING, TAPERED AND ROUNDED EDGES AND BE INSTALLED IN ALL WET AREAS AS INDICATED ON DRAWINGS.
- INDICATED ON DRAWINGS.

 5. FOR CONTROL JOINTS, PROVIDE U.S. GYPSUM #093 OR APPROVED EQUAL. INSTALL IN LOCATIONS AS RECOMMENDED BY INDUSTRY STANDARDS AND IN COMPLIANCE WITH
- U.S. GYPSUM STANDARDS.
 6. PROVIDE FASTENERS IN ACCORDANCE WITH ASTM C1002-01; UNLESS OTHERWISE NOTED OR INDICATED, PROVIDE TYPE 'S' BUGLE HEAD SCREWS FOR ATTACHMENT OF WALL BOARD TO METAL FRAMING, AND TYPE 'S' PAN HEAD SCREWS FOR ATTACHMENT OF
- FRAMING TO DOOR FRAMES.

 7. PROVIDE ALL INCIDENTAL AND ACCESSORY MATERIALS, TOOLS, EQUIPMENT, AND METHODS REQUIRED FOR SATISFACTORY COMPLETION OF GYPSUM WALL BOARD CONSTRUCTION INCLUDING ACCESS DOORS AND PANELS.

8. APPLY CONTINUOUS BEAD OF SEALANT AT ALL JOINTS OF WALL BOARD ABUTTING

- ADJACENT CONSTRUCTION, INCLUDING AROUND FRAMED OPENINGS AND OTHER PROTRUSIONS THROUGH WALL BOARD. WHERE SEALANT IS EXPOSED, PROVIDE POLY-SULFIDE SEALANT; WHERE UNEXPOSED, PROVIDE ACOUSTIC SEALANT.

 9. APPLY PRE-FILL COMPOUND TO JOINT IN ACCORDANCE WITH INDUSTRY STANDARDS. APPLY EMBEDDING COMPOUND REINFORCING TAPE CENTERED OVER JOINT; APPLY SKIM COAT. AFTER TAPING AND EMBEDDING COMPOUND IS DRY, APPLY SECOND COAT FILLING AND TAPER FLUSH WITH SURFACE: NO SECOND COAT REQUIRED AT INTERIOR
- ANGLES. FIRE TAPE PENETRATIONS AT DEMISING WALLS, CORRIDOR ENVELOPE AND OTHER RATED ASSEMBLIES.

 10. PROVIDE FINAL FINISH THAT IS SMOOTH, WITHOUT DIVOTS, BUMPS, BOWS OR ANY OTHER SURFACE BLEMISH, READY TO RECEIVE PAINT.
- TILE

 1. INSTALL TILE IN AREAS INDICATED. USE ADHESIVES AND APPLY ONLY AS RECOMMENDED BY MANUFACTURER AND IN ACCORDANCE WITH INDUSTRY STANDARDS.

 2. INSTALLERS MUST BE SPECIALISTS WITH A MINIMUM OF TWO (2) YEARS EXPERIENCE.
- ALL INSTALLATION SHALL CONFORM TO THE LATEST APPLICABLE TILE COUNCIL OF AMERICA AND ANSI STANDARDS.
 DO NOT COMMENCE INSTALLATION UNTIL SUBSTRATE HAS BEEN MADE SUITABLE FOR
- TILE INSTALLATION.

 5. REVIEW ALL AREAS TO RECEIVE TILE FLOORING (PRIOR TO SUBMITTING ESTIMATE)
 TO DETERMINE THE REQUIRED EXTENT OF SUBFLOOR PREPARATION.
- SET AND GROUT TILE WHEN AMBIENT TEMPERATURE IS AT LEAST 50 AND RISING. ALIGN ALL JOINTS AND CORNERS.
 CLEAN METAL AND WOOD SURFACES AND CONCRETE FLOORS, REMOVING ALL FOREIGN MATTER AND CONTAMINANTS SUCH AS GREASE, OIL, DUST, WATER, SURFACE DIRT, OLD SEALANTS OR GLAZING COMPOUNDS AND PROTECTIVE COATINGS. METAL SHALL BE
- CLEANED BY MECHANICAL OR SOLVENT PROCEDURES.

 8. INSTALL TILE TO CONCRETE SUBSTRATE PER TCA STANDARD F113-89 WITH TIGHTLY BUTTED JOINTS, TO PATTERN INDICATED IN THE DRAWINGS, OR AS SPECIFIED BY OWNER. VERIFY LAYOUT AND CUTS WITH PROJECT MANAGER PRIOR TO COMMENCEMENT OF WORK. CUT TILE AT WALL INTERSECTIONS FOR CONCEALMENT BY BASE WHERE APPLICABLE. VARY MORTAR THICKNESS, AS NECESSARY, TO ACCOMMODATE VARIATION
- IN THE TILE THICKNESS.

 9. CLOSE AREAS IN WHICH TILE IS BEING PLACED TO TRAFFIC AND OTHER WORK. DEEP AREA CLOSED UNTIL TILE IS FIRMLY SET. PROTECT FLOORING FROM DAMAGE.
- REPLACE DAMAGED TILE AT NO ADDITIONAL COST TO OWNER.

 10. INSTALL TILE TO WOOD SURFACES AND ALUMINUM GLAZING CHANNEL AND METAL BASE WITH DOW CORNING 795 SILICONE BUILDING SEALANT. BEADS AT 6" ON CENTER
- MAXIMUM.

 11. GROUT FLUSH WITH TILE EDGES. WIPE TILES WITH CHEESE CLOTH INSTEAD OF
- 12. DAMP CURE PER MORTAR AND GROUT MANUFACTURER'S RECOMMENDATIONS.

GLASS AND GLAZING 1. PROVIDE TEMPERED GLASS, GRAD "B", STYLE #1, TYPE "1", QUALITY 03, 1/2"

- THICK, UNLESS OTHERWISE NOTED. ALL GLASS TO BE CLEAR GLASS.

 2. ALL GLASS EDGES SHALL BE GROUND SMOOTH AND POLISHED.

 3. GENERAL GLASS SHALL BE q3 IN ACCORDANCE WITH FEDERAL SPECIFICATIONS DD-G-
- 451 AND FGMA GLAZING MANUAL.
 4. STOREFRONT GLASS SHALL BE AS REQUIRED FOR THE SIZES AND CONDITIONS
 DETAILED FRAME SECTION SHALL BE EXPOSED WHERE INDICATED. FRAME FINISH
 SHALL BE FACTORY MILL FINISH. REFER TO ELEVATION PLAN FOR TYPE OF FINISH
- SHALL BE FACTORY MILL FINISH. REFER TO ELEVATION PLAN FOR TYPE OF FINISH COLOR.

 5. PROVIDE RESILIENT NEOPRENE BLOCKS 70 TO 90 SHORE A DUROMETER HARDNESS AND RESILIENT ACCESSORIES DESIGNED FOR POSITIONING GLASS IN RABBETS.
- 6. PROVIDE CLIPS ON NON-CORROSIVE METAL WITH ROUNDED EDGES DESIGNED FOR CONTACT BLOCKS, NOT GLASS.

 7. PROVIDE STANDARD PREFORMED GLAZING TAPE, STANLOCKE 400, TRIMCO 440, OR
- APPROVED.

 8. PROVIDE NON-SHRINKING ELASTROMERIC TAPER WHERE REQUIRED.

 9. USE SILICONE SEALANT DOW #795 OR GE SILPRUF, CLEAR, OR APPROVED EQUAL.
 USE ONLY IF REQUIRED BY LOCAL BUILDING CODES, OTHERWISE ALL STOREFRONT
 GLASS SHALL HAVE A 1/4" VERTICAL CLEAR SPACE BETWEEN GLASS PANELS.
- ALL EDGES, DRILLED HOLES AND NOTCHES SHALL BE FACTORY CUT AND/OR FACTORY FORMED, TOUCH-UP "RAW" EDGES TO MATCH FRAME.
 INSTALL IN ACCORDANCE WITH FGMA RECOMMENDATIONS UNLESS NOTED OTHERWISE.
 VERIFY THAT FRAMES TO RECEIVE GLAZING ARE SQUARE AND TRUE, THAT PERIMETER CLEARANCES ARE SUFFICIENT TO PREVENT "POINT LOADING", AND THAT SURFACES
- ARE CLEAN, DRY AND READY TO RECEIVE GLAZING MATERIALS. REMOVE ALL PROTECTIVE COATING FROM FRAMING SURFACES.

 13. CENTER GLASS IN RABBETS AND POSITION SO AS TO MAINTAIN CLEARANCES ON ALL SIDES, INDOORS AND OUT, IN ACCORDANCE WITH FGMA RECOMMENDATIONS. SHIM AS
- REQUIRED TO POSITION AGAINST FIXED STOPS AND FRAME BARS.

 14. SET ALL EXTRUSIONS IN CORRECT LOCATIONS AS SHOWN IN THE DETAILS. THEY SHALL BE LEVEL, FLUSH SQUARE PLUMB AND IN ALIGNMENT WITH OTHER WORK.

 15. UPON COMPLETION, REMOVE ALL EXCESS SEALANT AND MATERIALS FROM SURFACES;
- WASH AND CLEAN ALL GLASS FRAMING MEMBERS.

 16. WHERE ALUMINUM ITEMS ARE TO BE ERECTED AND IN CONTACT WITH DISSIMILAR MATERIALS, PROVIDE CONTACT SURFACES WITH COATING OF AN IMPROVED ZINC CHROMATE PRIMER IN MANNER TO OBTAIN NOT LESS THAN 1.0 MIL DRY FILM THICKNESS

SUSPENDED CEILING SYSTEM

MANUFACTURER OF THE MATERIAL BEING CLEANED.

GRID SYSTEM "USG" TYPE DX 15/16" EDGE

- PROVIDE HOLD DOWN CLIPS WITH UL CLASSIFICATION LABEL.
 WORK INCLUDED: PROVIDE SUSPENDED CEILING SYSTEM WHERE SHOWN ON THE DRAWINGS. AS SPECIFIED HEREIN, AND AS NEEDED FOR A COMPLETE AND PROPER INSTALLATION.
 USE ADEQUATE NUMBERS OF SKILLED WORKMEN WHO ARE THOROUGHLY TRAINED AND EXPERIENCED IN THE NECESSARY CRAFTS AND WHO ARE COMPLETELY FAMILIAR WITH
- THE SPECIFIED REQUIREMENTS AND THE METHODS NEEDED FOR PROPER PERFORMANCE OF THE WORK OF THIS SECTION.

 4. DO NOT BEGIN INSTALLATION IN ANY AREA UNTIL SUFFICIENT MATERIALS ARE ON THE JOBSITE TO COMPLETE THE WORK OF THIS SECTION IN THAT AREA.
- PROVIDE THE MANUFACTURER'S HEAVY DUTY SUSPENSION SYSTEM, COMPLYING WITH REQUIREMENTS OF GOVERNMENTAL AGENCIES HAVING JURISDICTION, AND AS APPROVED BY THE ARCHITECT.
 PROVIDE OTHER MATERIALS, NOT SPECIFICALLY DESCRIBED BUT REQUIRED FOR A COMPLETE
- AND PROPER INSTALLATION, AS SELECTED BY THE CONTRACTOR SUBJECT TO THE APPROVAL INSTALLATION, AS SELECTED OF THE ARCHITECT.

 7. EXAMINE THE AREA AND CONDITIONS UNDER WHICH WORK OF THIS SECTION WILL BE PERFORMED CORRECT CONDITIONS ARE DETRIMENTAL TO TIMELY AND PROPER COMPLETION
- OF THE WORK. DO NOT PROCEED UNTIL UNSATISFACTORY CONDITIONS ARE CORRECTED.

 8. EXCEPT AS MODIFIED BY REQUIREMENTS OF GOVERNMENTAL AGENCIES HAVING JURISDICTION, INSTALL THE WORK OF THIS SECTION IN STRICT ACCORDANCE WITH THE MANUFACTURER'S INSTALLATION RECOMMENDATIONS AS APPROVED BY THE ARCHITECT.

 9. PROVIDE LATERAL BRACING AS REQUIRED BY PERTINENT CODES AND REGULATIONS. SECURE

LATERAL BRACING TO STRUCTURAL MEMBERS. SECURE AT RIGHT ANGLES TO THE DIRECTION

- OF THE PARTITION AND FOUR-WAYS IN LARGE CEILING AREAS.

 10. MAKE ALL FINISHED SURFACES LEVEL, OR TRUE TO PLANE WHERE PLANE IS DESIGNED TO BE OTHER THAN LEVEL, WITHIN A TOLERANNCE OF 1 IN 1000, AND STRAIGHT WITHIN A TOLERANCE OF 1 IN 1000.

 11. IN ADDTION TO OTHER STIPULATED REQUIREMENTS FOR CLEANING, COMPLETELY REMOVE FINGER PRINTS AND TRACES OF SOIL FROM THE SURFACES OF EXPOSED PORTIONS,
- 12. MATERIALS
 SUSPENSION SYSTEM AS REQUIRED TO SUPPORT GYPSUM BOARD PANELS, FIXTURES AND
 OTHER COMPONENTS AS INDICATED, INCLUDING ANCHORAGES, HANGERS, RUNNERS, CROSS
 RUNNERS, SPLINES, CLIPS, MOLDING, FASTENERS AND OTHER MEMBERS, DEVICES AND

USING ONLY THOSE CLEANING MATERIALS RECOMMENDED FOR THE PURPOSE BY THE

ACCESSORIES. COMPLY WITH ASTM C635. 2' X 4' GRID.

HANGER WIRE - NOT LESS THAN 12 GAUGE (0.106") GALVANIZED STEEL. TYPE - DIRECT HUNG OR INDIRECT FROM DUCTS, PIPES OR CONDUIT. EXPOSED FINISH - WHITE BAKED ENAMEL EDGE MOLDING - METAL CHANNEL TYPE WITH SINGLE FLANGE EXPOSED.

CITY OF MESA - BUILDING SAFETY NOTES

REQUIRED FIRE APPARATUS ACCESS ROAD DURING CONSTRUCTION OR DEMOLITION. THE ACCESS ROAD SHALL BE A MINIMUM OF 20 FEET WIDE AND SHALL BE AN ALL-WEATHER DRIVING SURFACE, GRADED TO DRAIN STANDING WATER AND ENGINEERED TO BEAR THE IMPOSED LOADS OF FIRE APPARATUS (74,000 LBS/24,000 LBS PER AXLE) WHEN ROADS ARE WET. FOR EXAMPLE, A MINIMUM OF SIX (6) INCHES OF ABC COMPACTED TO 90% OVER AN APPROVED BASE WOULD MEET THE REQUIREMENT.

THE ACCESS ROAD SHALL BE EXTENDED TO WITHIN 200 FEET OF ANY COMBUSTIBLE MATERIALS AND/OR ANY LOCATION ON THE JOBSITE WHERE ANY PERSON(S) SHALL BE WORKING FOR A MINIMUM OF FOUR (4) CONTINUOUS HOURS IN ANY DAY. A CLEARLY VISIBLE SIGN MARKED "FIRE DEPARTMENT ACCESS", IN RED LETTERS, SHALL BE PROVIDED AT THE ENTRY TO THE ACCESS ROAD.

ALL OPEN TRENCHES SHALL HAVE STEEL PLATES CAPABLE OF MAINTAINING THE INTEGRITY OF THE ACCESS ROAD DESIGN WHEN THESE TRENCHES CROSS AN ACCESS ROAD. THESE ACCESS ROADS MAY BE TEMPORARY OR PERMANENT. THIS POLICY APPLIES ONLY DURING CONSTRUCTION AND/OR DEMOLITION. PERMANENT ACCESS PER THE MESA FIRE CODE SHALL BE IN PLACE PRIOR TO ANY FINAL INSPECTION OR CERTIFICATE OF OCCUPANCY.

WATER SUPPLY FOR FIRE PROTECTION. AN APPROVED WATER SUPPLY FOR CONSTRUCTION SITE SHALL MEET THE REQUIREMENTS OF APPENDIX CHAPTERS B AND C. THE MINIMUM FIRE FLOW REQUIREMENT WHEN CONTRACTOR OR DEVELOPER BRINGS COMBUSTIBLE MATERIALS ON SITE IS 1,500 GPM AT 25 PSI. AT LEAST ONE FIRE HYDRANT SHALL BE WITHIN 500 FEET OF ANY COMBUSTIBLE MATERIAL AND CAPABLE OF DELIVERING THE MINIMUM FIRE FLOW REQUIREMENT. THIS HYDRANT OR HYDRANTS MAY BE EITHER TEMPORARY OR PERMANENT AS THE PROJECT SCHEDULE PERMITS.

IN ADDITION, THERE ARE TIMES WHEN HYDRANTS AND VALVES MUST BE CLOSED TEMPORARILY FOR REPAIR WORK OR CONSTRUCTION OF THE WATER SYSTEM. THE DEVELOPER/CONTRACTOR IS RESPONSIBLE FOR ENSURING THAT THE WATER SUPPLY IS AVAILABLE AT ALL TIMES. WHEN THE WORK IS COMPLETE, DEVELOPER/CONTRACTOR SHALL MAKE SURE THAT THE FIRE HYDRANTS ARE ACTIVE AND THE VALVES ARE OPEN. IFC CHAPTER 14

COMPLIANCE IS REQUIRED WITH ALL PROVISIONS AND REQUIREMENTS OF IBC CHAPTER 33, SAFEGUARDS DURING CONSTRUCTION, AND; IFC CHAPTER 14 AND NFPA 241, FIRE SAFETY DURING CONSTRUCTION AND DEMOLITION.

CITY OF MESA - SOLID WASTE NOTES

ALL COMMERCIAL PROPERTIES SHALL BE DESIGNED WITH ENCLOSURES TO ACCOMMODATE (1) REFUSE AND (1) RECYCLING ENCLOSURE FOR EVERY 20,000 SQUARE FEET OF BUILDING SPACE. RESTAURANTS WHICH ARE DESIGNED ON A SINGLE PAD SHALL HAVE A MINIMUM (1) REFUSE AND (1) RECYCLING ENCLOSURE. THE ENCLOSURES CAN BE SET UP AS DOUBLES OR SINGLES TO MAXIMIZE THE USE OF THE PROPERTY.



1 2 5 5 WEST RIO SALADO PARKWAY
SUITE 2 0 7
TEMPE, A Z 8 5 2 8 1
PHONE 4 8 0 . 2 6 8 . 2 9 0 0
FAX 4 8 0 . 2 6 8 . 2 9 0 5

W W W . A R I Z A D O . N E T



THESE PLANS ARE INSTRUMENTS
OF PROFESSIONAL SERVICE AND ARE
PROTECTED BY COMMON LAW,
STATUTORY AND OTHER RESERVED
RIGHTS INCLUDING COPYRIGHT. THEY
MAY NOT BE REPRODUCED OR USED
FOR ANY PURPOSE WITHOUT THE
WRITTEN CONSENT OF a.d.Arizado.

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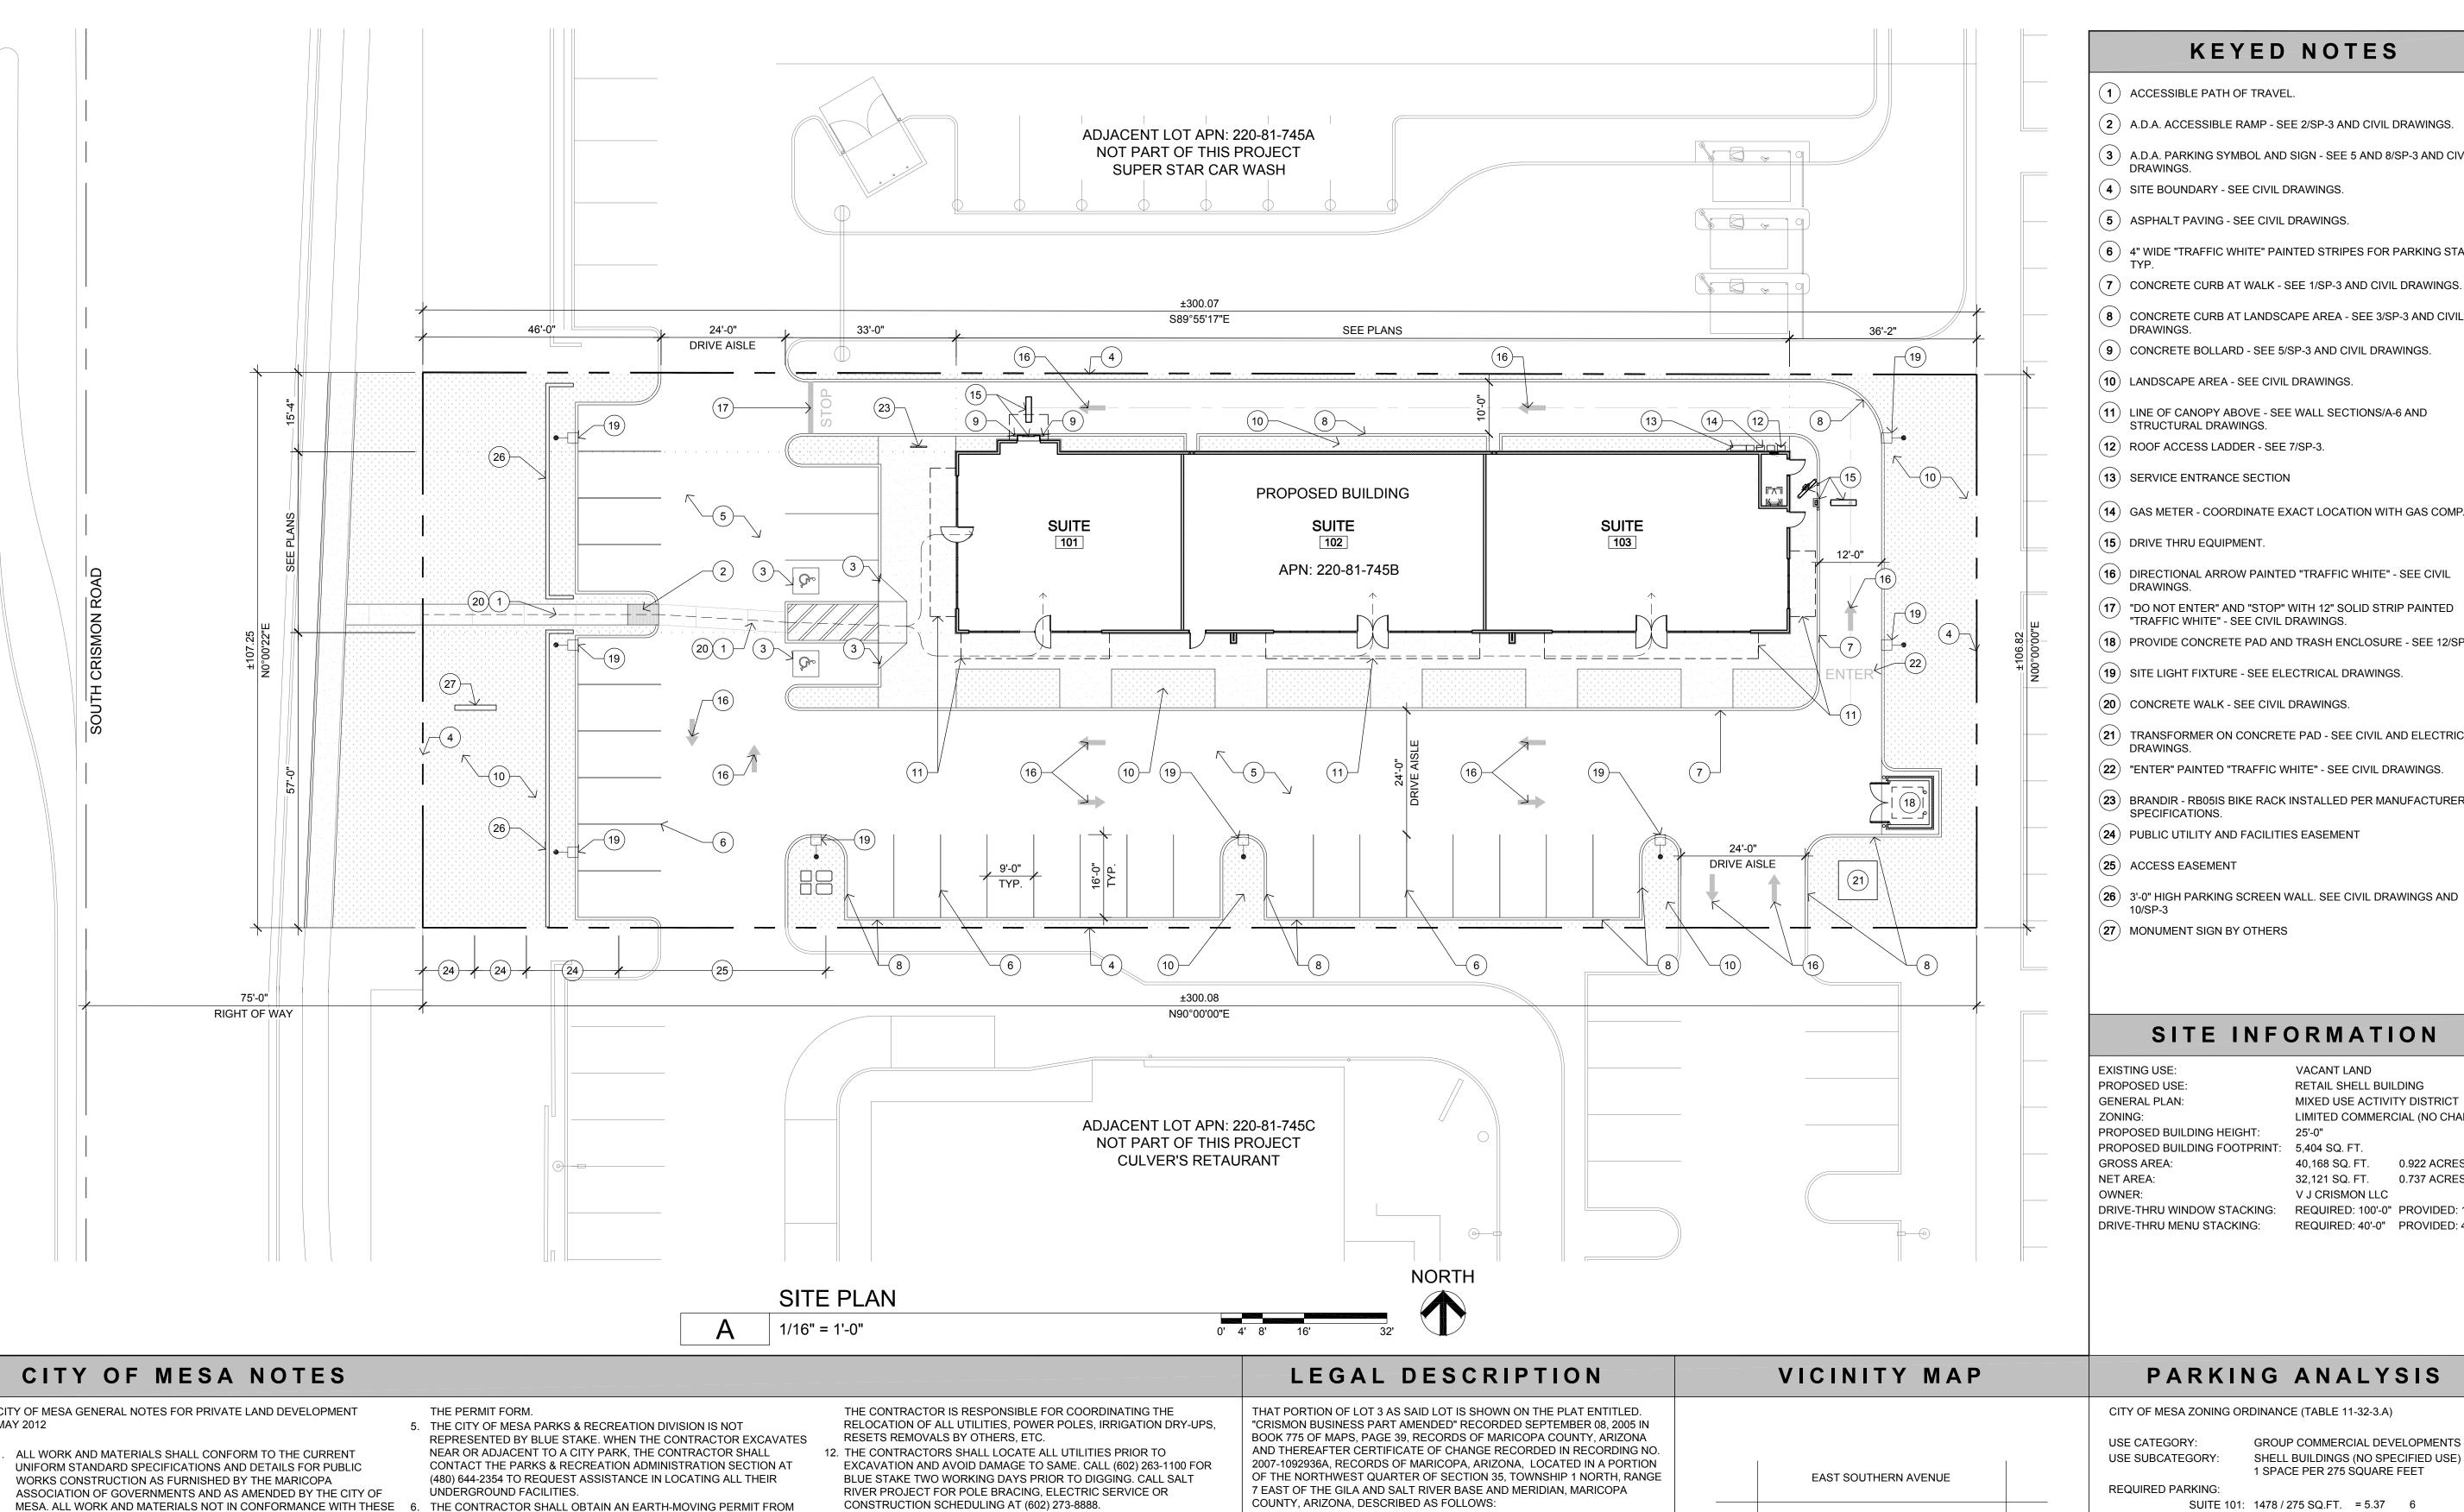
ELL BUILDING
THERN & SOUTH CRISMON
7 SOUTH CRISMON ROAD

SHEET TITLE

DATE 4/2/18
SCALE AS NOTED
DRAWN BW
CHECKED CC

SP-1

SHEET NO



KEYED NOTES

- (1) ACCESSIBLE PATH OF TRAVEL.
- (2) A.D.A. ACCESSIBLE RAMP SEE 2/SP-3 AND CIVIL DRAWINGS.
- (3) A.D.A. PARKING SYMBOL AND SIGN SEE 5 AND 8/SP-3 AND CIVIL
- (4) SITE BOUNDARY SEE CIVIL DRAWINGS.
- (5) ASPHALT PAVING SEE CIVIL DRAWINGS.
- (6) 4" WIDE "TRAFFIC WHITE" PAINTED STRIPES FOR PARKING STALL.
- (8) CONCRETE CURB AT LANDSCAPE AREA SEE 3/SP-3 AND CIVIL
- (9) CONCRETE BOLLARD SEE 5/SP-3 AND CIVIL DRAWINGS.
- (10) LANDSCAPE AREA SEE CIVIL DRAWINGS.
- (11) LINE OF CANOPY ABOVE SEE WALL SECTIONS/A-6 AND STRUCTURAL DRAWINGS.
- (12) ROOF ACCESS LADDER SEE 7/SP-3.
- (13) SERVICE ENTRANCE SECTION
- (14) GAS METER COORDINATE EXACT LOCATION WITH GAS COMPANY
- (15) DRIVE THRU EQUIPMENT.
- (16) DIRECTIONAL ARROW PAINTED "TRAFFIC WHITE" SEE CIVIL
- (17) "DO NOT ENTER" AND "STOP" WITH 12" SOLID STRIP PAINTED "TRAFFIC WHITE" - SEE CIVIL DRAWINGS.
- (18) PROVIDE CONCRETE PAD AND TRASH ENCLOSURE SEE 12/SP-3
- (19) SITE LIGHT FIXTURE SEE ELECTRICAL DRAWINGS.
- (20) CONCRETE WALK SEE CIVIL DRAWINGS.
- (21) TRANSFORMER ON CONCRETE PAD SEE CIVIL AND ELECTRICAL
- (22) "ENTER" PAINTED "TRAFFIC WHITE" SEE CIVIL DRAWINGS.
- (23) BRANDIR RB05IS BIKE RACK INSTALLED PER MANUFACTURER'S SPECIFICATIONS.
- (24) PUBLIC UTILITY AND FACILITIES EASEMENT
- (25) ACCESS EASEMENT
- (26) 3'-0" HIGH PARKING SCREEN WALL. SEE CIVIL DRAWINGS AND
- (27) MONUMENT SIGN BY OTHERS

SITE INFORMATION

EXISTING USE: VACANT LAND RETAIL SHELL BUILDING PROPOSED USE: MIXED USE ACTIVITY DISTRICT GENERAL PLAN: LIMITED COMMERCIAL (NO CHANGE) PROPOSED BUILDING HEIGHT: PROPOSED BUILDING FOOTPRINT: 5,404 SQ. FT. **GROSS AREA:** 40,168 SQ. FT. NET AREA: V J CRISMON LLC DRIVE-THRU WINDOW STACKING:

32,121 SQ. FT. 0.737 ACRES REQUIRED: 100'-0" PROVIDED: 177'-0"

REQUIRED: 40'-0" PROVIDED: 40'-0"

CITY OF MESA GENERAL NOTES FOR PRIVATE LAND DEVELOPMENT

- 1. ALL WORK AND MATERIALS SHALL CONFORM TO THE CURRENT AMENDED SPECIFICATIONS AND DETAILS ARE SUBJECT TO REMOVAL AND REPLACEMENT AT THE CONTRACTOR'S EXPENSE.
- SEPARATE RIGHT-OF-WAY PERMITS ARE REQUIRED FOR ALL PUBLIC UTILITIES, PUBLIC STREET IMPROVEMENTS, AND RIGHT-OF-WAY LANDSCAPING. FOR INFORMATION REGARDING AVAILABILITY AND COST OF RIGHT-OF-WAY PERMITS, CONTACT THE DEVELOPMENT SERVICES DEPARTMENT AT (480) 644-4273 OR AT
- HTTP://WWW.MESAAZ.GOV/DEVSUSTAIN/CONSTRUCTIONPERMITS.ASPX. THE CONTRACTOR SHALL OBTAIN ALL PERMITS REQUIRED UNLESS OTHERWISE NOTED. CONTRACTORS MUST HOLD THE APPROPRIATE CLASS OF LICENSE AND SHALL HAVE ON FILE WITH THE PERMIT SERVICES SECTION PROOF OF INSURANCE COVERAGE. PERMITS BECOME INVALID AND MUST BE UPDATED IF WORK HAS NOT BEGUN WITHIN NINETY (90) DAYS. PERMITS ALSO BECOME INVALID IF THE CONTRACTOR'S INSURANCE LAPSES OR IS VOIDED.
- TWENTY FOUR (24) HOURS PRIOR TO THE COMMENCEMENT OF ANY WORK, CONSTRUCTION OR INSTALLATIONS ASSOCIATED WITH THIS PERMIT, THE PERMITTEE SHALL NOTIFY CITY OF MESA ENGINEERING DEPARTMENT AT (480) 644-2251 OF INTENT TO BEGIN AND REQUEST/SCHEDULE PRELIMINARY FIELD REVIEW AT THE PROJECT SITE WITH THE CITY OF MESA ENGINEERING DEPARTMENT CONSTRUCTION INSPECTOR (CITY INSPECTOR). FAILURE TO PROVIDE PROPER INSPECTION NOTIFICATION AS PRESCRIBED ABOVE SHALL RESULT IN THIS PERMIT BECOMING INVALID AND WORK BEING
- CONTRACTOR'S SHALL COMPLY WITH THE REQUIREMENTS TO OBTAIN THE NECESSARY RIGHT-OF-WAY PERMITS AND SHALL COMPLY WITH THE RIGHT-OF-WAY PERMIT CONDITIONS AS FOUND ON THE BACK OF

STOPPED.

- THE MARICOPA COUNTY ENVIRONMENTAL SERVICES DEPARTMENT AND SHALL COMPLY WITH ITS REQUIREMENTS FOR DUST CONTROL.
- 7. THE ENGINEER HEREBY CERTIFIES AS EVIDENCED BY A PROFESSIONAL SEAL & SIGNATURE, THAT ALL AFFECTED UTILITY COMPANIES BOTH PUBLIC AND PRIVATE HAVE BEEN CONTACTED AND ALL EXISTING AND/OR PROPOSED UTILITY LINES AND OTHER RELATED INFORMATION HAVE BEEN TRANSFERRED ONTO THESE PLANS. THE ENGINEER OR ARCHITECT ALSO HEREBY CERTIFIES THAT ALL EXISTING AND/OR PROPOSED PUBLIC RIGHT-OF-WAY AND EASEMENTS HAVE BEEN CORRECTLY PLOTTED/SHOWN.
- 8. THE ENGINEER, OR LAND SURVEYOR OF RECORD SHALL CERTIFY UPON COMPLETION OF CONSTRUCTION THAT ALL PUBLIC IMPROVEMENTS (WATER AND SEWER UTILITIES, STORM SEWER, CONCRETE, PAVING, STREET LIGHTS, ETC.) HAVE BEEN INSTALLED AT THE LOCATIONS AND ELEVATIONS SHOWN ON THE APPROVED PLANS. ANY CHANGES SHALL BE REFLECTED ON "AS-BUILT" DRAWINGS PROVIDED BY THE ENGINEER TO THE CITY'S ENGINEERING
- 9. THE REGISTERED ENGINEER OR LAND SURVEYOR SHALL CERTIFY THAT THE MINIMUM HORIZONTAL AND VERTICAL SEPARATIONS BETWEEN UTILITIES WITHIN PUBLIC RIGHT-OF-WAY AND EASEMENTS HAVE BEEN MAINTAINED AS REQUIRED BY LAW OR POLICY.

10. THE DEVELOPER SHALL PROVIDE ALL CONSTRUCTION STAKING FOR

THE PROJECT. 11. THE DEVELOPER OR THE ENGINEER IS RESPONSIBLE FOR ARRANGING FOR THE RELOCATION OR REMOVAL OF ALL UTILITIES OR FACILITIES THAT ARE IN CONFLICT WITH THE PROPOSED PUBLIC IMPROVEMENTS.

- CONSTRUCTION SCHEDULING AT (602) 273-8888. 13. WHEN GAS MAINS AND/OR SERVICES ARE EXPOSED, CONTACT THE
- CITY OF MESA AT (480) 644-2261 FOR INSPECTION OF THE EXPOSED PIPE AND COATING PRIOR TO BACKFILLING OF THE TRENCH. 14. CONTRACTORS SHALL COMPLY WITH THE PROVISIONS FOR TRAFFIC
- CONTROL AND BARRICADING PER THE CURRENT CITY OF MESA TRAFFIC BARRICADE MANUAL 15. IF A FIRE HYDRANT IS NEEDED TO OBTAIN CONSTRUCTION WATER, THE CONTRACTOR SHALL OBTAIN A FIRE HYDRANT METER FROM

16. IF DURING THE CONSTRUCTION OF A PUBLIC FACILITY, THE

PERMIT SERVICES AND PAY ALL APPLICABLE FEES AND CHARGES.

- CONTRACTOR FAILS TO OR IS UNABLE TO COMPLY WITH A REQUEST OF THE CITY INSPECTOR, AND IT IS NECESSARY FOR CITY FORCES TO DO WORK THAT IS NORMALLY THE CONTRACTOR'S RESPONSIBILITY, THE CITY SHALL BE JUSTIFIED IN BILLING THE CONTRACTOR. EACH INCIDENT REQUIRING WORK BY CITY FORCES SHALL BE COVERED BY A SEPARATE BILLING AT THE CURRENT APPLICABLE RATES.
- 17. THE CONTRACTOR IS ADVISED THAT DAMAGE TO PUBLIC SERVICES OR SYSTEMS AS A RESULT OF THIS PROJECT SHALL BE REPAIRED BY THE CONTRACTOR AND INSPECTED BY THE CITY INSPECTOR. UNLESS OTHERWISE APPROVED BY THE CITY, ALL REPAIRS SHALL BE DONE WITHIN 24 HOURS. THE CONTRACTOR IS ADVISED THAT ANY COSTS RELATED TO REPAIR OR REPLACEMENT OF DAMAGED PUBLIC SERVICES AND SYSTEMS AS A RESULT OF CONTRACTOR'S ACTIVITIES SHALL BE BORNE BY THE CONTRACTOR

COMMENCING AT A FOUND BRASS CAP IN HAND HOLE MARKING THE NORTHWEST CORNER OF SAID SECTION 35, FROM WHICH A FOUND ADOT ALUMINUM CAP MARKING THE WEST QUARTER CORNER OF SAID SECTION 35 BEARS SOUTH 00 DEGREES 00 MINUTES 22 SECONDS WEST, A DISTANCE OF 2636.41 FEET;

THENCE SOUTH 00 DEGREES 00 MINUTES 22 SECONDS WEST ALONG THE WEST LINE OF SAID NORTHWEST QUARTER, A DISTANCE OF 509.75 FEET.

THENCE SOUTH 89 DEGREES 55 MINUTES 57 SECONDS EAST, A DISTANCE OF 75.00 FEET TO A POINT ON THE WEST LINE OF SAID LOT 3 AND THE TRUE POINT OF BEGINNING;

DISTANCE OF 300.00 FEET OF SAID LOT 3; THENCE SOUTH 00 DEGREES 00 MINUTES 22 SECONDS WEST, ALONG THE

THENCE CONTINUING SOUTH 89 DEGREES 55 MINUTES 57 SECONDS EAST, A

THENCE NORTH 90 DEGREES 00 MINUTES 00 SECONDS WEST. A DISTANCE OF 300 FEET TO A POINT ON THE WEST LINE OF SAID LOT 3;

THENCE NORTH 00 DEGREES 00 MINUTES 22 SECONDS EAST ALONG THE WEST LINE. A DISTANCE OF 107.25 FEET TO THE TRUE NORTH POINT OF

APN: 220-81-745B

EAST LINE, A DISTANCE OF 106.89 FEET;

CITY OF MESA ZONING ORDINANCE (TABLE 11-32-3.A)

USE CATEGORY: GROUP COMMERCIAL DEVELOPMENTS USE SUBCATEGORY: SHELL BUILDINGS (NO SPECIFIED USE) 1 SPACE PER 275 SQUARE FEET REQUIRED PARKING: SUITE 101: 1478 / 275 SQ.FT. = 5.37 6

SUPERSTITION FREEWAY ---

EAST BASELINE ROAD

SUITE 102: 1959 / 275 SQ.FT. = 7.12 8 SUITE 102: 1967 / 275 SQ.FT. = 7.15 8 TOTAL REQUIRED PARKING STALLS: 22 TOTAL PROVIDED PARKING STALLS: 28

REQUIRED ACCESSIBLE PARKING: (TABLE 208.2) TOTAL REQUIRED PARKING STALLS:

TOTAL PROVIDED PARKING STALLS:

REQUIRED BICYCLE PARKING (SECTION 11-32-8)

TOTAL REQUIRED BICYCLE PARKING: 1:10 STALLS TOTAL PROVIDED BICYCLE PARKING:


A17392

1255 WEST RIO SALADO PARKWAY SUITE 207 TEMPE, AZ 85281 PHONE 480.268.2900

FAX 480.268.2905

W W W . A R I Z A D O . N E T



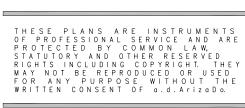


0.922 ACRES


R SOUTH CRI TH CRISMON F ARIZONA 8520


SHEET TITLE SITE PLAN

JOB NO DATE

4/2/18 AS NOTED SCALE DRAWN CHECKED SHEET NO

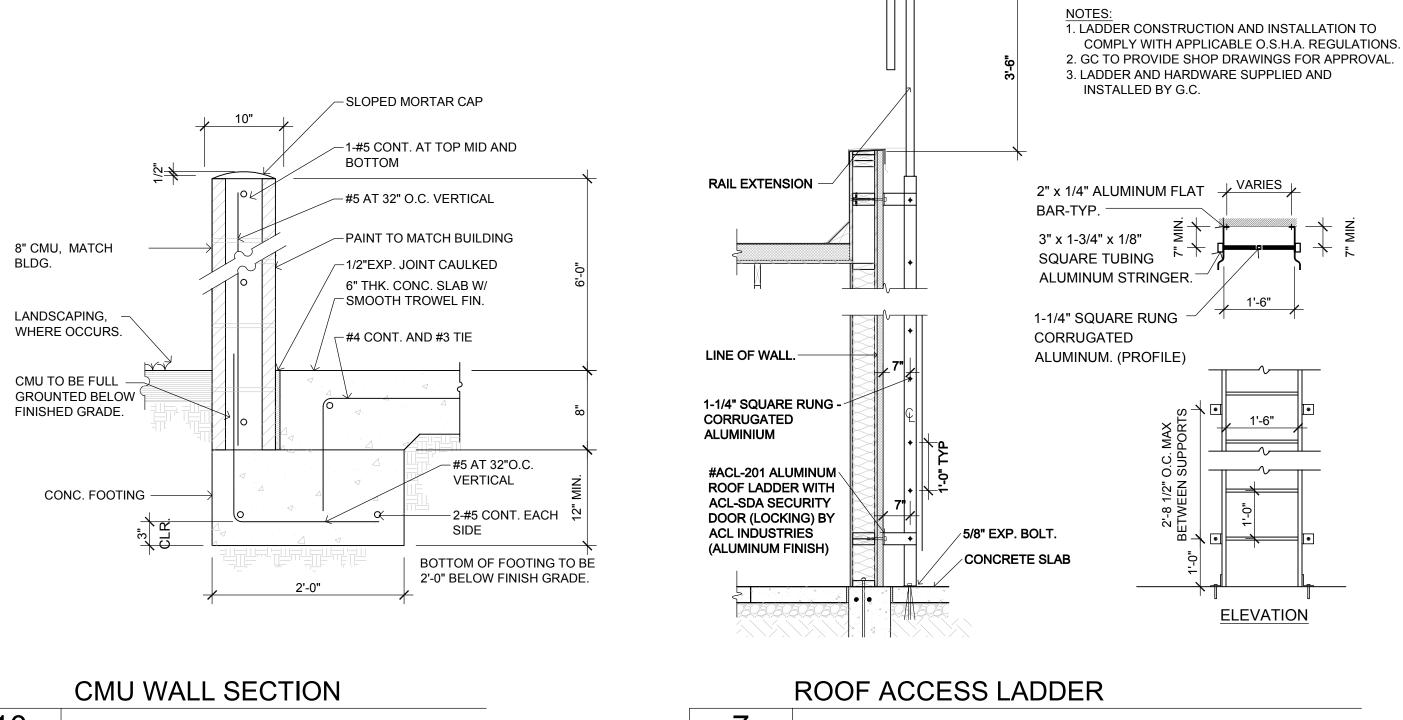

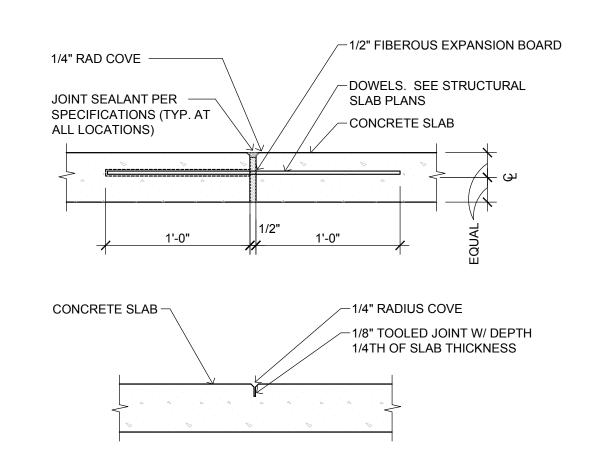


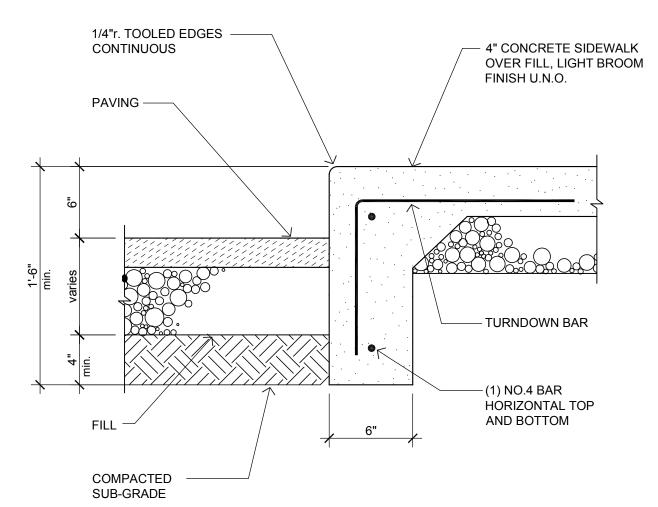






1" = 1'-0"

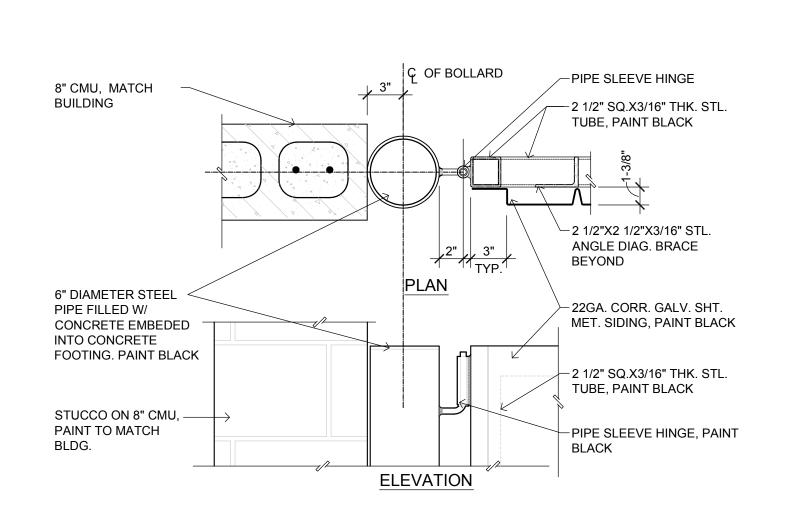


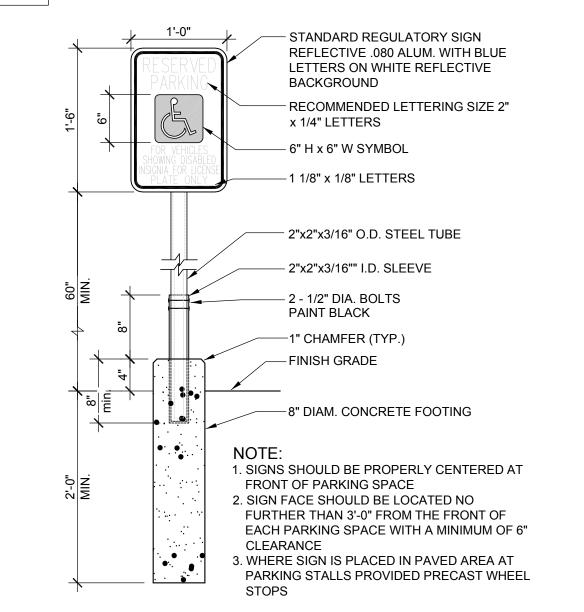

EXPANSION / CONTROL JOINT


1-1/2" = 1'-0"

ELEVATION

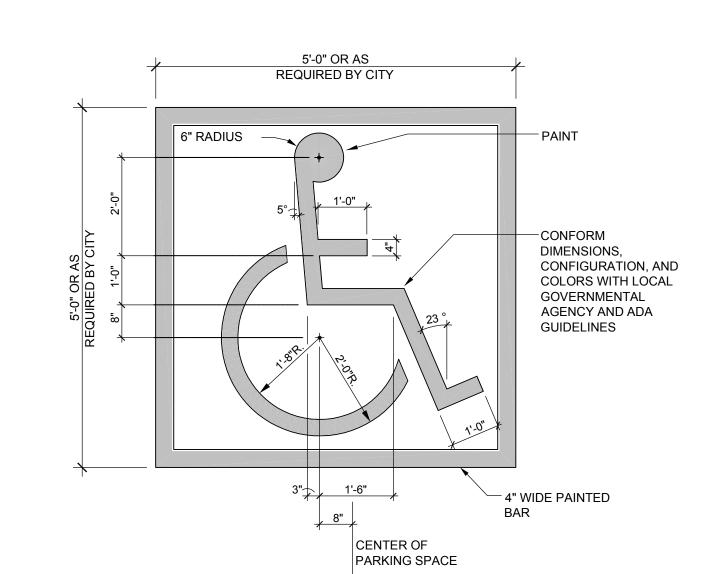

CONCRETE CURB AND WALK

1-1/2" = 1'-0"

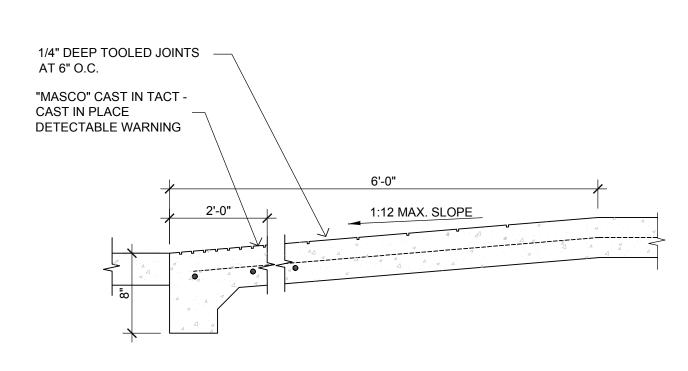

THESE PLANS ARE INSTRUMENTS OF PROFESSIONAL SERVICE AND ARE PROTECTED BY COMMON LAW, STATUTORY AND OTHER RESERVED RIGHTS INCLUDING COPYRIGHT. THEY MAY NOT BE REPRODUCED OR USED FOR ANY PURPOSE WITHOUT THE WRITTEN CONSENT OF a.d.Arizado.


TRASH GATE DETAIL

PIPE BOLLARD*—*<



A.D.A. PARKING SIGN

8 1" = 1'-0"

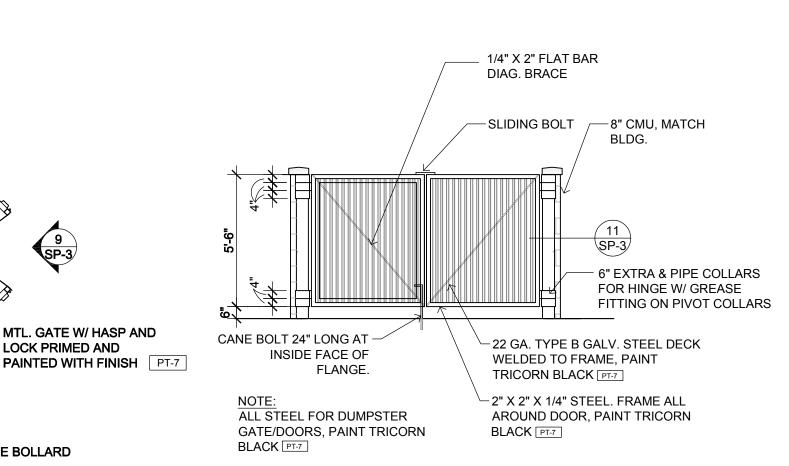


ADA SYMBOL DETAIL

3/4" = 1'-0"

6" ø STANDARD STL.PIPE FILLED -WITH CONCRETE AND PAINTED RED (2 COATS MIN.) EXISTING PAVEMENT 18" ø CONCRETE FOOTING -(2) NO. 6 BARS 12" LONG EACH -WAY, WELD TO PIPE

RAMP SECTION

1" = 1'-0"

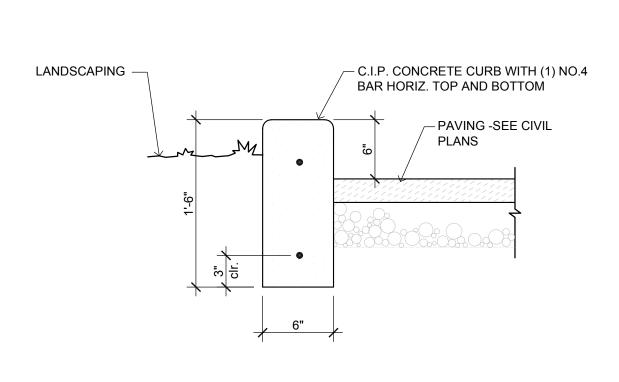

CAST IN PLACE CURB

SOUTHERN & SOUTH CRISMON 1257 SOUTH CRISMON ROAD MESA, ARIZONA 85208

SHEET TITLE

TITLE SHEET

JOB NO

A17392 DATE AS NOTED SCALE DRAWN CHECKED SHEET NO

PLAN AT TRASH ENCLOSURE

1/4" = 1'-0"

9'-5 1/2"

SLOPE DOWN

PAVING (SEE CIVIL

MTL. GATE W/ HASP AND

LOCK PRIMED AND

PIPE BOLLARD


1/4" = 1'-0"

ELEVATION AT TRASH ENCLOSURE GATES

3/4" = 1'-0"


BOLLARD DETAIL

3 1-1/2" = 1'-0"

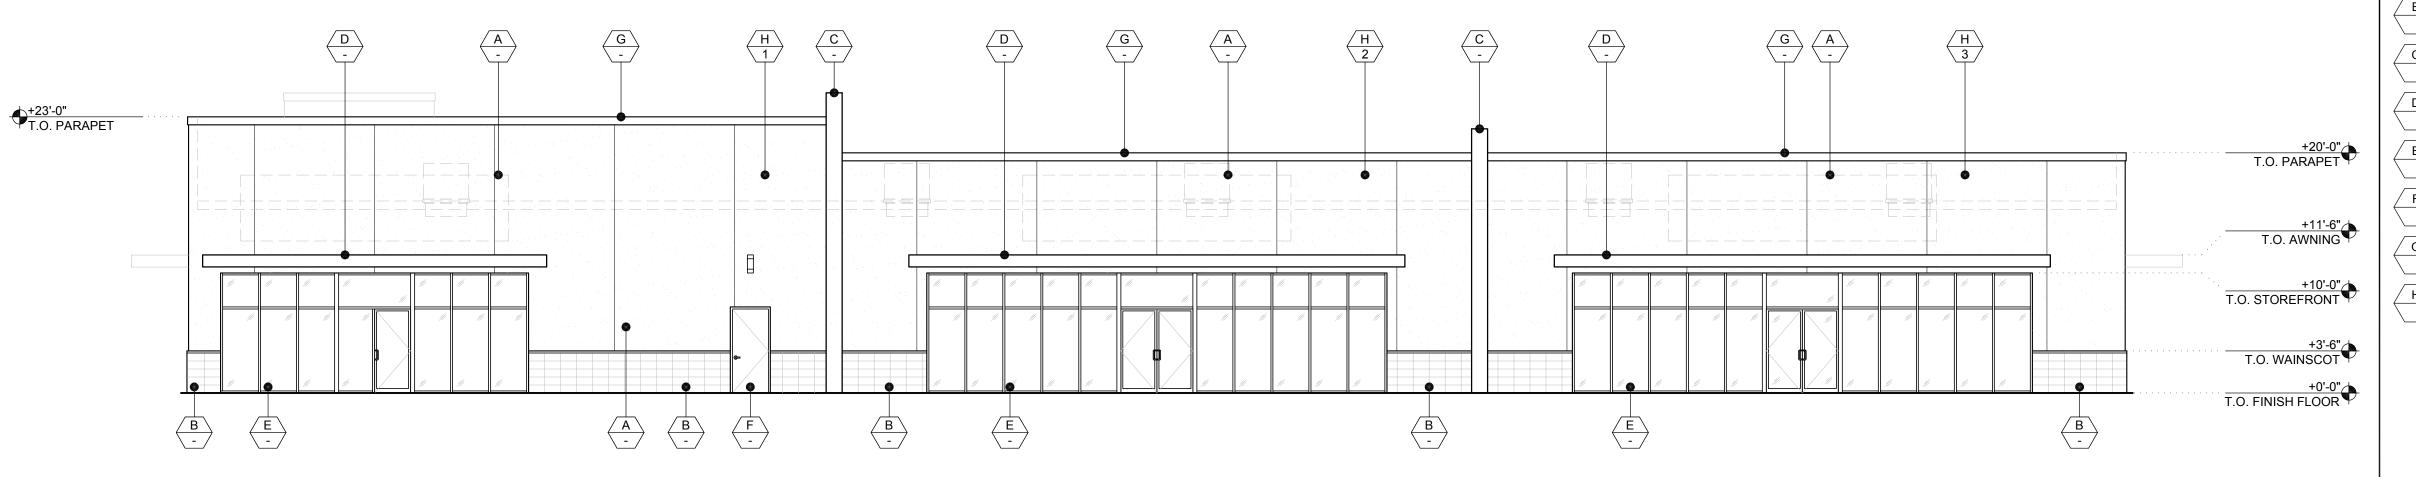


SOUTH ELEVATION

1/8" = 1'-0"

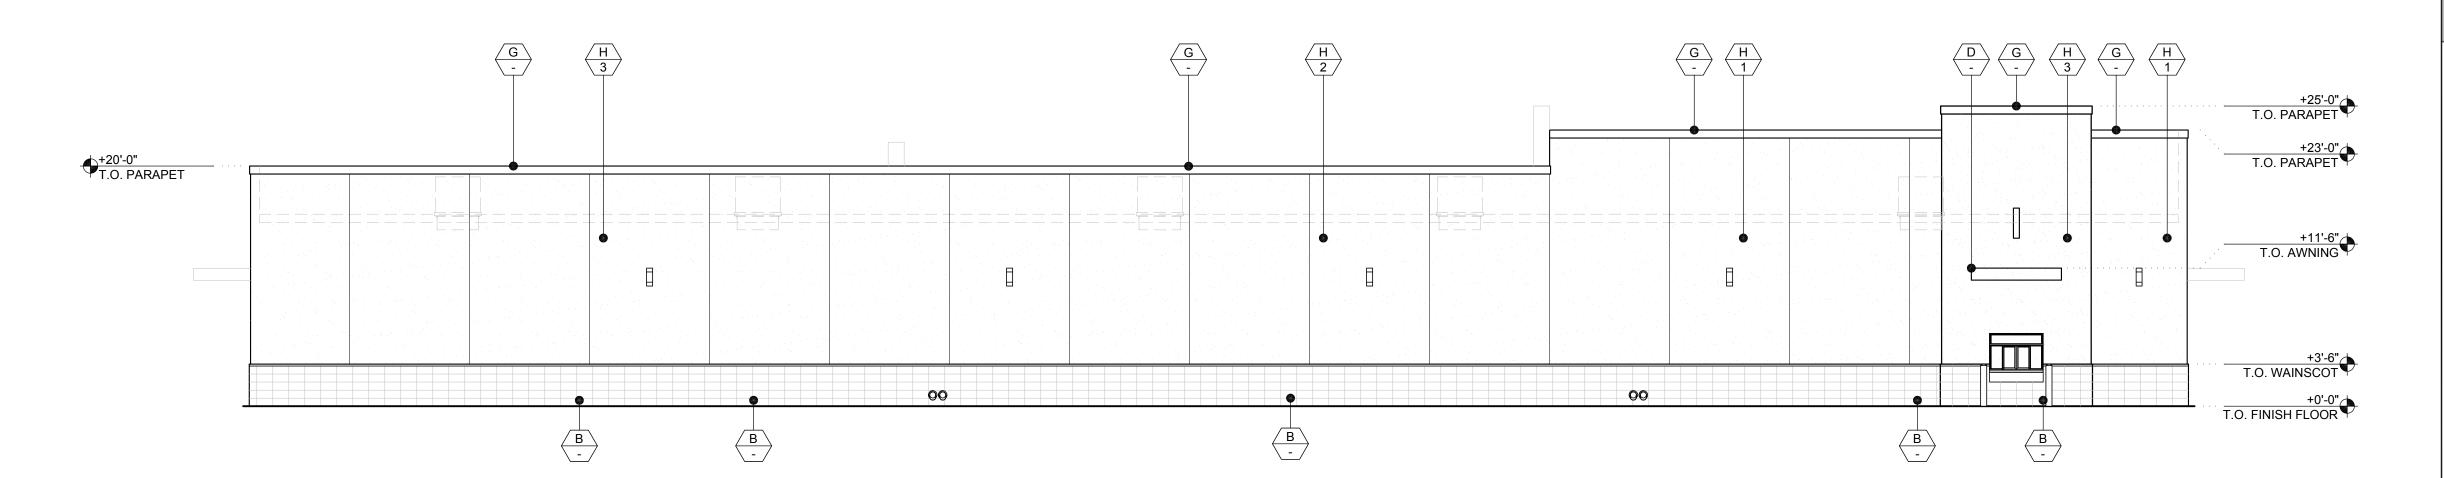


NORTH ELEVATION

В 1/8" = 1'-0"

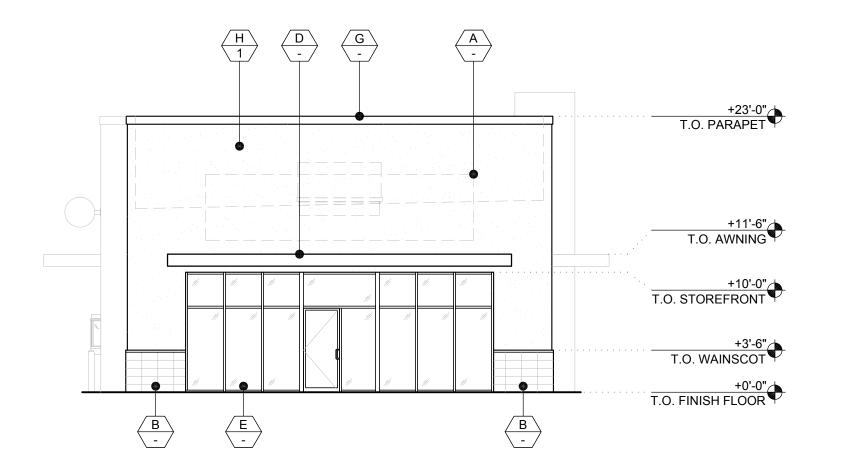

WEST ELEVATION 1/8" = 1'-0"

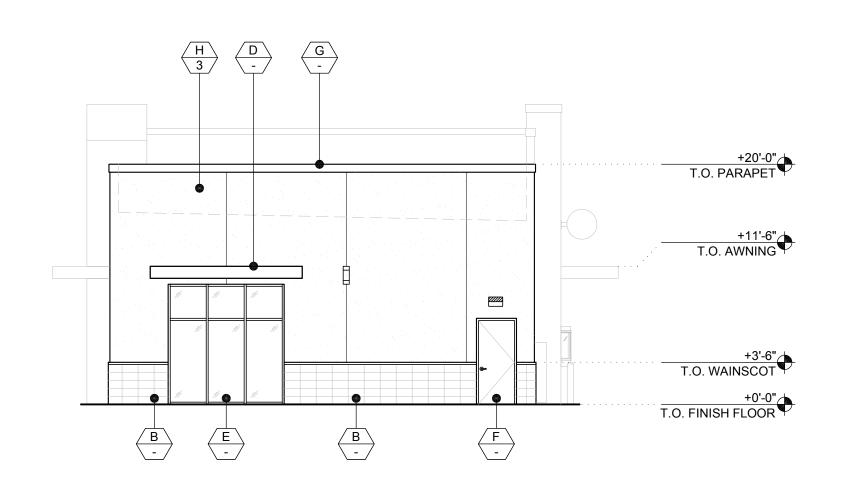

EAST ELEVATION

1/8" = 1'-0"

MATERIALS

SIGN BY TENANT. APPROVED UNDER SEPARATE REVIEW AND PERMIT

MSI METRO GRIS 12"x24" WITH STONE CAP

NORTH CLAD AL SERIES "GREY" WALL CLADDING SYSTEM

STEEL CANOPY - PAINT BLACK

KAWNEER 451T ALUM/GLASS STOREFRONT (1/4" INSULATED BRONZE TINTED TEMPERED GLASS, 20% MAX REFLECTIVITY) CLEAR ANODIZED ALUMINUM FINISH.


METAL DOOR AND FRAME - PAINT TO MATCH

METAL COPING - PAINT BLACK

WESTERN ONE COAT STUCCO SYSTEM

RCHITECTURE

1255 WEST RIO SALADO PARKWAY SUITE 207 T E M P E , A Z 8 5 2 8 1 PHONE 480.268.2900 F A X 4 8 0 . 2 6 8 . 2 9 0 5 W W W . A R I Z A D O . N E T

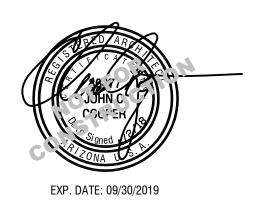

FINISHES

PAINT MFG: BEHR MODEL: -STYLE: PPU26-21 COLOR: OVERCAST

> PAINT MFG: BEHR MODEL: -STYLE: PPU26-17 COLOR: FAST AS THE WIND

PAINT MFG: BEHR MODEL: -STYLE: PPU26-22 COLOR: SUMMER STORM THESE PLANS ARE INSTRUMENTS OF PROFESSIONAL SERVICE AND ARE PROTECTED BY COMMON LAW, STATUTORY AND OTHER RESERVED RIGHTS INCLUDING COPYRIGHT. THEY MAY NOT BE REPRODUCED OR USED FOR ANY PURPOSE WITHOUT THE WRITTEN CONSENT OF a.d.Arizado.

SOUTHERN & SOUTH CRISMON 1257 SOUTH CRISMON ROAD MESA, ARIZONA 85208

GENERAL NOTES


- ALL ROOF MOUNTED EQUIPMENT SHALL BE FULLY SCREENED BY THE
- 2. ALL SIGNAGE SHALL BE REVIEWED AND APPROVED UNDER SEPARATE SUBMITTAL. ALL BUILDING MOUNTED UTILITY BOXES ARE TO BE PAINTED TO MATCH ADJACENT COLORS.

SHEET TITLE EXTERIOR ELEVATIONS

A17392


DATE SCALE AS NOTED DRAWN CHECKED

SHEET NO **A-5**

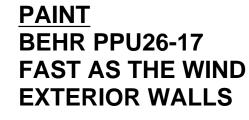



TILE
MSI
METRO GRIS 12"x24"
EXTERIOR WAINSCOT

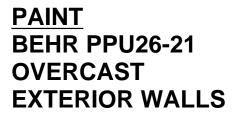



METAL
NORTH CLAD
AL PANEL SYSTEM SERIES
CHARCOAL GRAY
ACCENT











